

RIVIERA BEACH COMMUNITY DEVELOPMENT CORP. (RBCDC) PROTOTYPE SINGLE FAMILY HOME 2 STORY

Vacant Lot #673 West 1st Street Riviera Beach, FL 33404

PERMIT SET 06.22.18

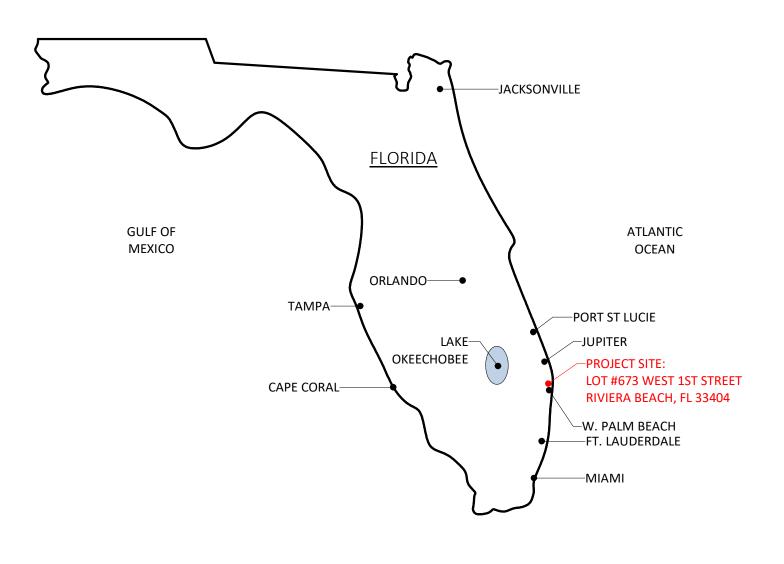

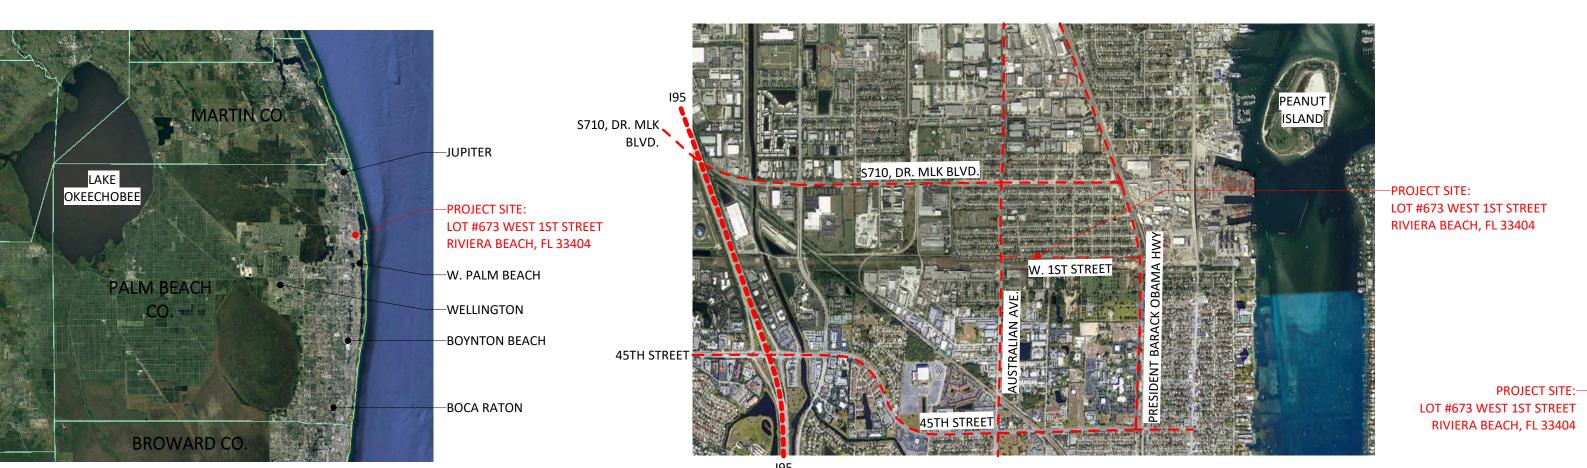




W. RIVIERA W. 6TH STREET
ELEMENTARY
SCHOOL

W. 3RD STREET
W. 3RD STREET
W. 2ND STREET

PROJECT LOCATION MAP

VICINITY MAP PROJECT AREA MAP

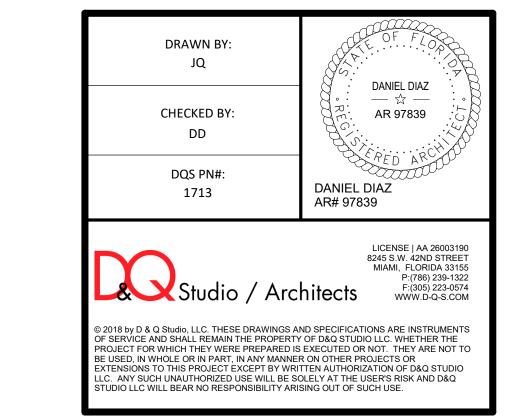

ARCHITECTURAL ABBREVIATIONS

L Length

LAV Lavatory

LBS Pounds

LD Linear Diffuser

LVT Luxury Vinyl Tile

MAX Maximum

MECH Mechanical

MIN Minimum

MTL Metal

N North

MULL Mullion

NAT Natural

NO/# Number

NOM Nominal

NTS Not to Scale

OA Overall

OFF Office

OC On Center

OH Overhead

OPNG Opening OPP Opposite

PLAS Plaster
PED Pedestal
PERIM Perimeter

OD Outside Dimension

OS Occupancy Sensor

PBD Particle Board
PCF Pounds Per Cubic Foot

PLAM Plastic Laminate

PIV Point indication Valve

PSF Pounds Per Square Foot

PSI Pound Per Square Inch

PTL Pressure Treated Lumber

PTW Pressure Treated Wood

REINF Reinforced/Reinforcing

RUB Rubber Wall Base

RUBTR Rubber Stair Tread RCP Reflected Ceiling Plan

RTU Rooftop Air Handling Unit

PVC Polyvinyl Chloride Pipe

PLBG Plumbing PLWD Plywood

PREFAB Prefabricated

PROP Proposed

PTN Partition

PT Porcelain Tile

QT Quarry Tile

RA Return Air

RAD/ R Radius RD Roof Drain

RE Relocated

REQ'D Required

REC Recessed RECPT Receptacle RLG Railing

S South

SHT Sheet

SIM Similar

SP Space

STD Standard STL Steel

STR Structural

SUP Support
SUSP Suspended

SW Sidewalk
T Thickness / Tread

TOB Top of Beam

TOC Top of Concrete

TOF Top of Footing
TOI Top of Insulation

TOS Top of Slab

TYP Typical

VERT Vertical

W/ With

WD Wood

TOW Top of Wall

UE Utility Easement

VTR Vent thru Roof

W Width / West

WCO Wall Cleanout

WP Weatherproof

VCT Vinyl Composition Tile

TOP Top of Parapet

UNO Unless Noted Otherwise

SAN Sanitary

SCHED Schedule

SPEC(S) Specifications(s)

SF Square Feet

RO Rough Opening

RM Room

R/W Right-of-Way

R Rise

PNL Panel

PNT Paint

NIC Not in Contract

MFR Manufactory

MISC Miscellaneous

MO Masonry Opening

MTD Mount (ed) (ing)

MCT Linoleum/Marmoleum Composite Tile

NGVD National Geodetic Vertical Datum

NRC Noise Reduction Coefficient

LF Linear Feet

LH Left Hand

LOC Location

LT Light

LVR Louver

ARCHITEC
∠ Angle ⊈ Center line Ø Diameter or round ± Plus or minus B Plate or property line c/c Center to Center
A/C Air Conditioner/ing AC Acoustical ACC Accessible ACFL Access Floor ACT Acoustical Ceiling Tile AD Area Drain ADDM Addendum ADJ Adjacent ADJT Adjustable AFF Above Finished Floor AFR Above Finished Roof AHU Air Handling Unit A.L. Arc Length ALUM Aluminum ALT Alternate ANOD Anodized AP Access Panel APPROXApproximate
BD Board BDR Bedroom BFF Below Finish Floor BTWN Between BLDG Building BLK Block BM Beam BOB Bottom of Beam BOP Bottom of Pipe BR Bathroom BS Both Sides BTU British Thermal Unit
CAB Cabinet CAS Casement CEM Cement CHR Chair rail CUFT Cubic Foot (Feet) CG Corner Guard CIR Circle C.I.P. Cast in Place CJ Control Joint CL Center Line CLF Chain Link Fence CLR Clear CLG Ceiling CLR Clear CMU Concrete Masonry U CO Clean Out COL Column CONC Concrete COMB Combination CONT Continuous COOR Coordination CPT Carpet CPTT Carpet Tile CS Cast Stone CSMT Casement CT Ceramic Tile CTR Counter CU Condensing Unit
DIA Diameter DIAG Diagonal DIFF Diffuser DIM Dimension DW Dishwasher DR Door or Dining Room DN Down DET Detail DWG Drawing

E East

EA Each

EC Eased Corner

EL Elevation

ELEC Electric

ELEV Elevator

ENCL Enclose

EXTG Existing

EXT Exterior

FIN Finish

FLR Floor

FT Feet

GA Gauge

GB Grab Bar GL Glass

GYP Gypsum

H/HT Height

HB Hose Bib

HDW Hardware

HDWD Hardwood

ID Inside Diameter
IN Inch / Inches

INSUL Insulation

JB Joint Bearing

JBOX Junction Box

INT Interior

JT Joint

HORZ Horizontal

GALV Galvanized

GUM Glass Unit Masonry GWB Gypsum Wallboard

FS Floor Sink

EQ Equal

ENGR Engineer (ing)

EQUIP Equipment

EWC Electric Water Cooler

FD Floor Drain / Fire Damper

FEC Fire Extinguisher Cabinet

EXP Exposed, Expansion

FE Fire Extinguisher

FF Finished Floor

GENERAL NOTES:

1. CONTRACTOR SHALL FIELD VERIFY ALL DIMENSIONS AND EXISTING CONDITIONS PRIOR TO BIDING AND START OF CONSTRUCTION. CONTRACTOR TO REPORT ANY DISCREPANCIES TO THE ARCHITECT.

2. CONTRACTOR SHALL COMPLY WITH ALL APPROVED APPLICABLE LOCAL, STATE AND FEDERAL BUILDING CODES, LAWS, REGULATIONS AND ORDINANCES.

 ALL MATERIALS AND EQUIPMENT UTILIZED IN THIS PROJECT SHALL BE UTILIZED AND INSTALLED IN STRICT ACCORDANCE WITH THE MANUFACTURER'S RECOMMENDATIONS AND SPECIFICATIONS.

4. ALL WORK DONE UNDER THE SUPERVISION OF THE CONTRACTOR SHALL BE DONE IN A NEAT AND WORKMAN-LIKE MANNER IN ACCORDANCE WITH ALL GOVERNING AGENCIES, RULES AND REPUTATIONS HAVING JURISDICTION.

5. UNDER NO CIRCUMSTANCES SHALL ASSUMPTIONS BY THE CONTRACTOR BE CONSIDERED THE DESIGN INTENT NOR THE APPROVAL OF ARCHITECT OR ENGINEER WITHOUT THEIR WRITTEN APPROVAL.

6. ALL SHOP DRAWINGS SHALL BE SUBMITTED TO THE ARCHITECT AND/OR ENGINEER FOR REVIEW PRIOR TO FABRICATION.

7. ALL SHOP DRAWINGS DIMENSIONS SHALL BE FIELD VERIFIED AND SHALL BEAR THE REVIEW STAMP, DATE AND SIGNATURE OF THE CONTRACTOR BEFORE SUBMITTAL TO ARCHITECT AND/OR ENGINEER.


8. CONTRACTOR SHALL BE RESPONSIBLE FOR REMOVING ALL DEBRIS DAILY FROM THE SITE AND FOR PROPERLY CLEANING ALL AREAS PRIOR TO FINAL ACCEPTANCE BY THE OWNER, INCLUDING BUT NOT LIMITED TO WINDOW, STOREFRONTS, FLOORS, CONSTRUCTION MATERIAL FROM THE SITE AND SHALL ALSO BE RESPONSIBLE FOR WALLS, DOORS, ETC. CONTRACTOR SHALL PROVIDE ITS OWN TRASH CONTAINER AT THE LOCATION SELECTED BY THE OWNER. ALL DEMOLITION AND CONSTRUCTION AREAS SHALL HAVE "NO SMOKING" SIGNS POSTED.

9. UPON COMPLETION OF THIS PROJECT, THE CONTRACTOR SHALL GIVE THE OWNER A COMPLETED SET OF RECORD DRAWINGS ("AS-BUILT") ALONG WITH THE WRITTEN GUARANTEES, AND ALL OPERATION AND MAINTENANCE MANUAL OF ALL EQUIPMENT AND FINISHES INSTALLED.

10. IT IS NOT THE INTENT OF THESE DRAWINGS TO SHOW EVERY MINOR DETAIL OF CONSTRUCTION. THE CONTRACTOR IS EXCEPTED TO FURNISH AND INSTALL ALL ITEMS TO COMPLETE ALL BUILDING SYSTEMS AND PROVIDE ALL APPURTENANCES FOR EQUIPMENT TO BE PLACED IN WORKING ORDER.

11. CONTRACTOR SHALL BE REQUIRED TO CONTINUOUSLY MAINTAIN ALL NECESSARY UTILITIES DURING CONSTRUCTION.

SYMBOLS AND TAGS

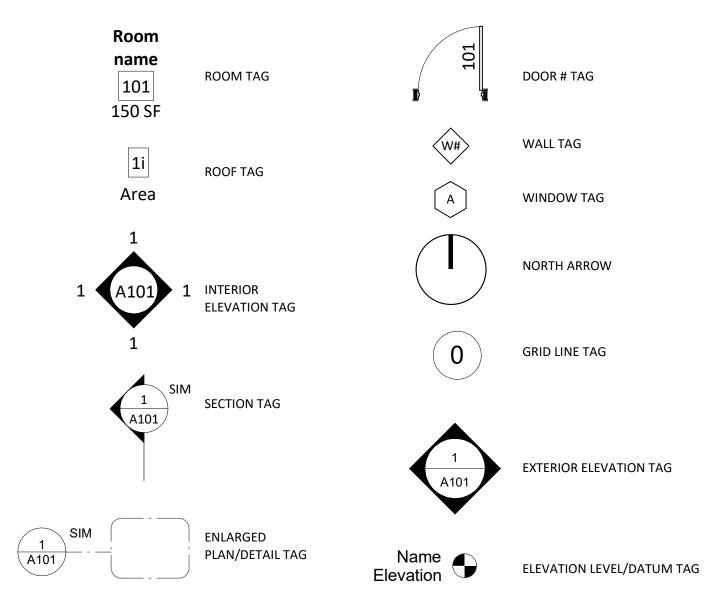

DRAWING NUMBER	DRAWING TITLE	ISSUE DATE	REVISION #	REVISION DATE
COVER SHEET, DRAW	ING INDEX & NOTES		I.	
A-000	COVER SHEET	06.22.18		
A-001	DRAWING INDEX & NOTES	06.22.18		
SITE PLANS		•	1	
AS-100	LANDSCAPING SITE PLAN	06.22.18		
AS-110	SITE PLAN & FENCE DETAILS	06.22.18		
ARCHITECTURAL				
A-100	1ST & 2ND FLOOR PLANS	06.22.18		
A-110	ENLARGED STAIR PLAN, SECTIONS AND DETAILS	06.22.18		
A-120	STAIR SECTIONS	06.22.18		
A-200	ELEVATIONS	06.22.18		
A-300	BUILDING SECTIONS	06.22.18		
A-400	REFLECTED CEILING PLAN (RCP)	06.22.18		
A-500	ROOF PLAN	06.22.18		
A-600	WALL SECTIONS	06.22.18		
A-700	FINISH SCHEDULE & DETAILS	06.22.18		
A-710	INTERIOR ELEVATIONS	06.22.18		
A-720	INTERIOR DETAILS	06.22.18		
A-800	DOOR & WINDOW DETAILS	06.22.18		
STRUCUTRAL				
S-1	STRUCTURAL FOUNDATION PLAN AND DETAILS	06.22.18		
S-2	STRUCTURAL FIRST FLOOR FRAMING PLAN AND DETAILS	06.22.18		
S-3	STRUCTURAL ROOF FRAMING PLAN AND DETAILS	06.22.18		
MECHANICAL				
M-1	MECHANICAL FLOOR PLAN	06.22.18		
M-2	MECHANICAL NOTES, DETAILS AND SCHEDULES	06.22.18		
ELECTRICAL		•		
E-1	ELECTRICAL FLOOR PLAN	06.22.18		
E-2	ELECTRICAL NOTES, DETAILS AND SCHEDULES	06.22.18		
PLUMBING				
P2	PLUMBING NOTES, DETAILS AND SCHEDULES	06.22.18		
P-1	PLUMBING FLOOR PLAN	06.22.18		

APPLICABLE CODES:

1. THE DESIGN AND CONSTRUCTION OF THIS PROJECT SHALL COMPLY WITH THE FOLLOWING CODES AND STANDARDS. SHOULD THERE BE A CONFLICT BETWEEN ANY CODE REQUIREMENTS, COMPLY WITH THE REQUIREMENT THAT PROVIDES THE GREATEST DEGREE OF LIFE SAFETY.

• FBC (FLORIDA BUILDING CODE), SIXTH EDITION (2017) RESIDENTIAL

FBC (FLORIDA BUILDING CODE), SIXTH EDITION (2017) BUILDING
FBC (FLORIDA BUILDING CODE), SIXTH EDITION (2017) EXISTING BUILDING
FBC (FLORIDA BUILDING CODE), SIXTH EDITION (2017) MECHANICAL

FBC (FLORIDA BUILDING CODE), SIXTH EDITION (2017) PLUMBING
 FBC (FLORIDA BUILDING CODE), SIXTH EDITION (2017) ACCESSIBILITY

NEC (NATIONAL ELECTRICAL CODE) 2014, FLORIDA SIXTH EDITION (2017)
 FFPC (FLORIDA FIRE PREVENTION CODE), SIXTH EDITION (2017)

PROJECT SUSTAINABILITY REQUIREMENTS:

PROJECT IS TO INCLUDED ALL ENERGY STAR RATED/LABELED;
 APPLIANCES, LIGHT FIXTURES, DOORS, WINDOWS AND HVAC SYSTEM.
 ALL PLUMBING FIXTURES ARE TO BE LOW FLOW PER PLUMBING

SPECIFICATIONS.

3. ALL PAINT, ADHESIVES AND SEALANTS TO BE LOW VOC.



RIVIERA BEACH COMMUNITY DEVELOPMENT CORP. (RBCDC) PROTOTYPE SINGLE FAMILY HOME 2 STORY DANIEL DIAZ DATE REVISION DRAWN BY: PROJECT SITE ADDRESS: AR 97839 Vacant Lot #673 West 1st Street Riviera Beach, FL 33404 DQS PN#: 1713 DANIEL DIAZ AR# 97839 DATE: 06.22.18 DRAWING INDEX PERMIT SET Studio / Architects & NOTES 2018 by D & Q Studio, LLC. THESE DRAWINGS AND SPECIFICATIONS ARE INSTRUMENT F SERVICE AND SHALL REMAIN THE PROPERTY OF D&Q STUDIO LLC. WHETHER THE OJECT FOR WHICH THEY WERE PREPARED IS EXECUTED OR NOT. THEY ARE NOT E USED, IN WHOLE OR IN PART, IN ANY MANNER ON OTHER PROJECTS OR ENSIONS TO THIS PROJECT EXCEPT BY WRITTEN AUTHORIZATION OF D&O STUD C. ANY SUCH UNAUTHORIZED USE WILL BE SOLELY AT THE USER'S RISK AND D&Q FUDIO LLC WILL BEAR NO RESPONSIBILITY ARISING OUT OF SUCH USE.

GENERAL PLANTING NOTES:

ALL SIZES SHOWN FOR PLANT MATERIAL ON THE PLANS ARE TO BE CONSIDERED MINIMUM. ALL PLANTS MUST MEET OR EXCEED THESE MINIMUM REQUIREMENTS FOR BOTH HEIGHT AND SPREAD. ANY OTHER REQUIREMENT FOR SPECIFIC SHAPE OR EFFECT AS NOTED ON THE PLAN(S) WILL ALSO BE REQUIRED FOR FINAL ACCEPTANCE.

ALL PLANTS MATERIAL FURNISHED BY THE LANDSCAPE CONTRACTOR SHALL BE FLORIDA #1 OR BETTER AS ESTABLISHED BY "GRADES AND STANDARDS FOR FLORIDA NURSERY PLANTS" AND "GRADES AND STANDARDS FOR FLORIDA NURSERY TREES". ALL PLANTS SHALL BE SOUND, HEALTHY, VIGOROUS, WELL BRANCHED AND FREE OF DISEASES AND INSECT EGGS AND LARVAE AND SHALL HAVE ADEQUATE ROOT SYSTEMS. TREES AND SHRUBS FOR PLANTING ROWS SHALL BE UNIFORM IN SIZE AND SHAPE. WHERE ANY REQUIREMENTS ARE OMITTED FROM THE PLANT LIST, THE PLANT FURNISHED SHALL BE NORMAL FOR THE VARIETY.

ALL PLANTS MATERIALS AS INCLUDED HEREIN SHALL BE WARRANTED BY THE LANDSCAPE CONTRACTOR FOR A MINIMUM PERIOD AS FOLLOWS: ALL TREES, PALMS, SHRUBS, VINES, GROUNDCOVER AND MISCELLANEOUS PLANTING MATERIALS FOR 12 MONTHS. THE LANDSCAPE CONTRACTOR SHALL NOT BE RESPONSIBLE FOR DAMAGE CAUSED BY VANDALISM, VIOLENT WIND STORMS OR OTHER ACTS OF GOD BEYOND CONTROL. REPLACEMENT SHALL OCCUR WITHIN TWO WEEKS OF REJECTION AND GUARANTEED FROM DATE OF INSTALLATION. LANDSCAPE CONTRACTOR SHALL REPAIR DAMAGE TO OTHER PLANTS OR LAWNS DURING PLANT REPLACEMENTS AT NO ADDITIONAL COST.

ALL PLANT MATERIAL SHALL BE PLANTED IN PLANTING SOIL THAT IS DELIVERED TO THE SITE IN A CLEAN LOOSE AND FRIABLE CONDITION. ALL SOIL SHALL HAVE A WELL DRAINED CHARACTERISTIC. SOIL MUST BE FREE OF ALL ROCKS, STICKS, AND OBJECTIONABLE MATERIAL INCLUDING WEEDS AND WEED SEED AS PER CSI SPECIFICATION.

SIX INCHES (6") OF PLANTING SOIL 50/50 SAND/TOPSOIL MIX REQUIRED AROUND AND BENEATH THE ROOT BALL OF ALL TREES AND PALMS, AND 1 CUBIC YARD PER 50 BEDDING OR GROUND PLANTS.

ALL LANDSCAPE AREAS SHALL BE COVERED WITH EUCALYPTUS OR STERILIZED SEED FREE MELALEUCA MULCH OF A MINIMUM DEPTH OF THREE INCHES (3") OF COVER WHEN SETTLED CYPRESS BACK MULCH SHALL NOT BE USED. ROOTBALLS WILL RECEIVE LESS THAN ONE INCH (1") MULCH WITH NO MULCH TOUCHING TRUCK OR ROOT COLLAR. DO NOT APPLY MULCH AGAINST THE TRUNKS OF WOODY SHRUBS

ALL PLANT MATERIAL SHALL BE THOROUGHLY WATERED IN AT THE TIME OF PLANTING; NO DRY PLANTING PERMITTED. ALL PLANT MATERIALS SHALL BE PLANTED SUCH THAT THE TOP OF THE PLANT BALL IS FLUSH WITH THE SURROUNDING GRADE.

ALL LANDSCAPE AND LAWN AREAS SHALL BE IRRIGATED BY A FULLY AUTOMATIC SPRINKLER SYSTEM ADJUSTED TO PROVIDE 100% COVERAGE OF ALL LANDSCAPE AREAS. ALL HEADS SHALL BE ADJUSTED TO 100% OVERLAP AS PER MANUFACTURES SPECIFICATIONS AND PERFORMANCE STANDARDS UTILIZING A RUST FREE WATER SOURCE. EACH SYSTEM SHALL BE INSTALLED WITH A RAIN SENSOR. LANDSCAPE WORK SHALL BE COORDINATED WITH LANDSCAPE IRRIGATION WORK. LANDSCAPE CONTRACTOR SHALL ENSURE THAT NO PLANTINGS WILL INTERFERE WITH THE PROPER COVERAGE. LANDSCAPE CONTRACTOR SHALL POINT OUT SITUATIONS WHERE MINOR ADJUSTMENTS OR RELOCATION OR ADDITION OF SPRINKLER HEADS MAY BE MOST BENEFICIAL FOR LANDSCAPE WORK AS A WHOLE. PROVIDE BUBBLERS ON SEPARATE ZONES FOR ALL NEWLY PLANTED AND TRANSPLANTED TREES UNLESS ALTERNATE APPROACH TO PROVIDE ADDITIONAL WATER IS APPROVED BY OWNER AND PROJECT ARCHITECT.

IT IS THE SOLE RESPONSIBILITY OF THE LANDSCAPE CONTRACTOR TO INSURE THAT ALL NEW PLANTINGS RECEIVE ADEQUATE WATER DURING THE INSTALLATION AND DURING ALL PLANT WARRANTY PERIODS. DEEP WATERING OF ALL NEW TREES AND PALMS AND ANY SUPPLEMENTAL WATERING THAT MAY BE REQUIRED TO AUGMENT NATURAL RAINFALL AND SITE IRRIGATION IS MANDATORY TO INSURE PROPER PLANT DEVELOPMENT AND SHALL BE

ALL PLANT MATERIAL SHALL BE INSTALLED WITH FERTILIZER, WHICH SHALL BE STATE APPROVED AS A COMPLETE FERTILIZER CONTAINING THE REQUIRED MINIMUM OF TRACE ELEMENTS IN ADDITION TO N-P-K, WHICH 50% OF THE NITROGEN SHALL BE DERIVED FROM ORGANIC SOURCE AS PER CSI SPECIFICATIONS.

CONTRACTORS ARE RESPONSIBLE FOR COORDINATING WITH THE OWNERS AND APPROPRIATE PUBLIC AGENCIES TO ASSIST IN LOCATING AND VERIFYING ALL UNDERGROUND UTILITIES PRIOR TO EXCAVATION. CARE SHALL BE TAKEN NOT TO DISTURB OR DAMAGE AND UNDERGROUND CONSTRUCTION OR UTILITIES. ANY DAMAGE TO THERE FACILITIES DURING THE PLANTING OPERATIONS WILL BE REPAIRED AT THE EXPENSE OF THE LANDSCAPE CONTRACTOR IN A MANNER APPROVED BY THE OWNER. WHERE UNDERGROUND OBSTRUCTIONS WILL NOT PERMIT THE PLANTING MATERIALS IN ACCORDANCE WITH THE PLANS, NEW LOCATIONS SHALL BE APPROVED BY THE PROJECT ARCHITECT.

ALL SOD AREAS AS INDICATED ON THE LANDSCAPE PLAN SHALL RECEIVE STENOTAPHRUM SECUNDATUM, ST. AUGUSTINE 'FLORATAM' SOLID SOD. ALL SOD SHALL BE INSTALLED IN SUCH A MANNER THAT THERE IS AN EVEN SURFACE, STAGGERED PATTERN. SOD WILL BE GREEN IN COLOR AND IN GOOD HEALTH. NO OVERLAP, GAPS, DAMAGE, INSECTS, DISEASE AND LESS THAN 10% CHLOTOSIS WILL BE PERMITTED. ALL GAPS WILL BE FILLED WITH CLEAN NATIVE SOIL.

PLAN SHALL MEET FLORIDA-FRIENDLY LANDSCAPE REQUIREMENTS.


AND WORKMANSHIP ACCORDING TO CONTRACT.

SITE WATER SHALL BE VERIFIED BY CONTRACTOR PRIOR TO SUBMISSION OF BIDS.

NO SUBSTITUTIONS SHALL BE MADE WITHOUT THE APPROVAL FROM THE OWNER. INTENDED SUBSTITUTIONS SHALL BE INDICATED ON THE BID


UPON WRITTEN REQUEST FROM THE CONTRACTOR, OWNER AND/OR PROJECT ARCHITECT SHALL PERFORM INSPECTION TO DETERMINE COMPLETION OF CONTRACT.

FOLLOWING INSPECTION, CONTRACTOR WILL BE NOTIFIED, IN WRITING, BY OWNER AND/OR PROJECT ARCHITECT OF ACCEPTANCE OF COMPLETION WITH REGARDS TO PLANT MATERIAL

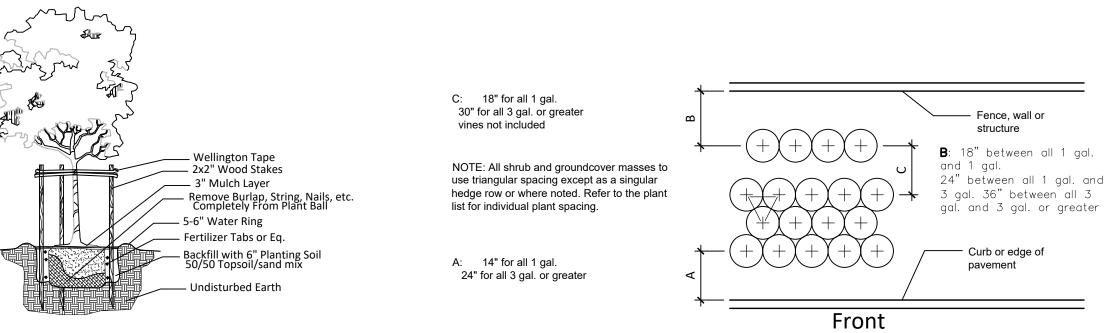


Small Tree Planting Detail


Typical Planting Spacing

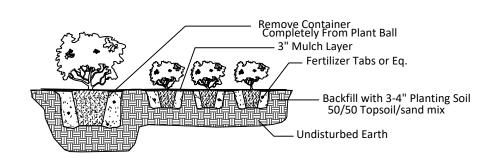


Shrub & Ground Cover Planting Detail

PLANTING LIST SCHEDULE

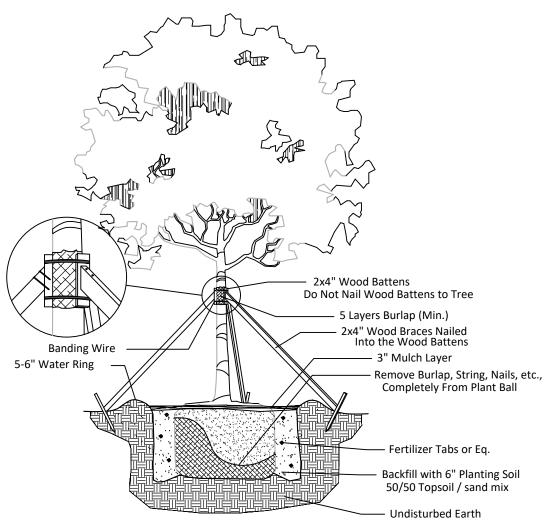

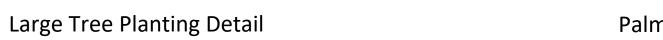

SCIENTIFIC NAME

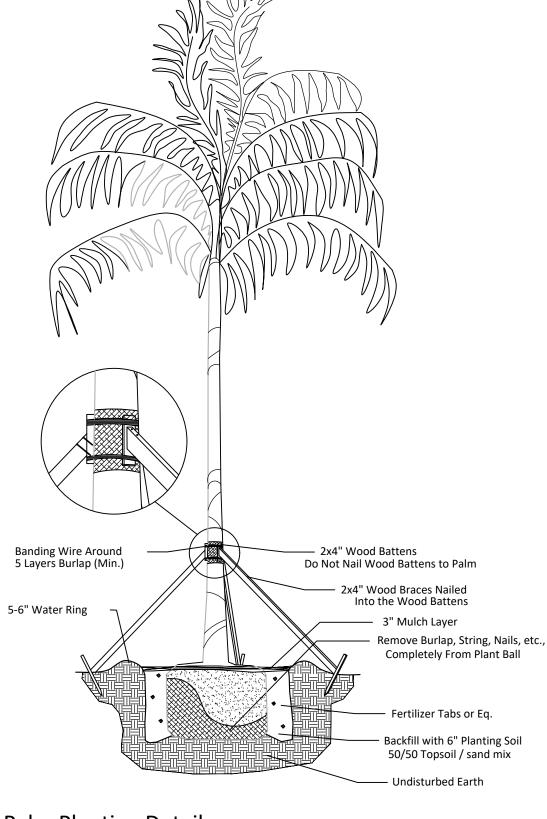

Palm Planting Detail

14'X6-8', 6' C.T. SHADE TREE, NATIVE QUERCUS VIRGINIANA LIVE OAK COCCOLOBA UVIFERA SEA GRAPE 12'X5, 2" DBH SHADE TREE, NATIVE 25 GAL. CONOCARPUS ERECTUS ACCENT TREE, NATIVE VAR. SERICEUS 25 GAL. 5' C.T. ADONIDIA MERRILLII CHRISTMAS PALM MULTI-TRUNK, (MULTI TRUNK) 25 GAL. NON-NATIVE CORDYLINE TERMINALIS RED SISTER 3 GAL. NON-NATIVE NON-NATIVE

COMMON NAME





EXISTING PALM TREES, TO REMAIN

SOD, REFER TO GENERAL PLANTING NOTES.

LANDSCAPING BOULDER

NOTE: REFER TO PLANTING LIST SCHEDULE FOR NEW PLANTINGS


MULCH ALL PLANTING BEDS

MULCH, REFER TO GENERAL PLANTING NOTES.







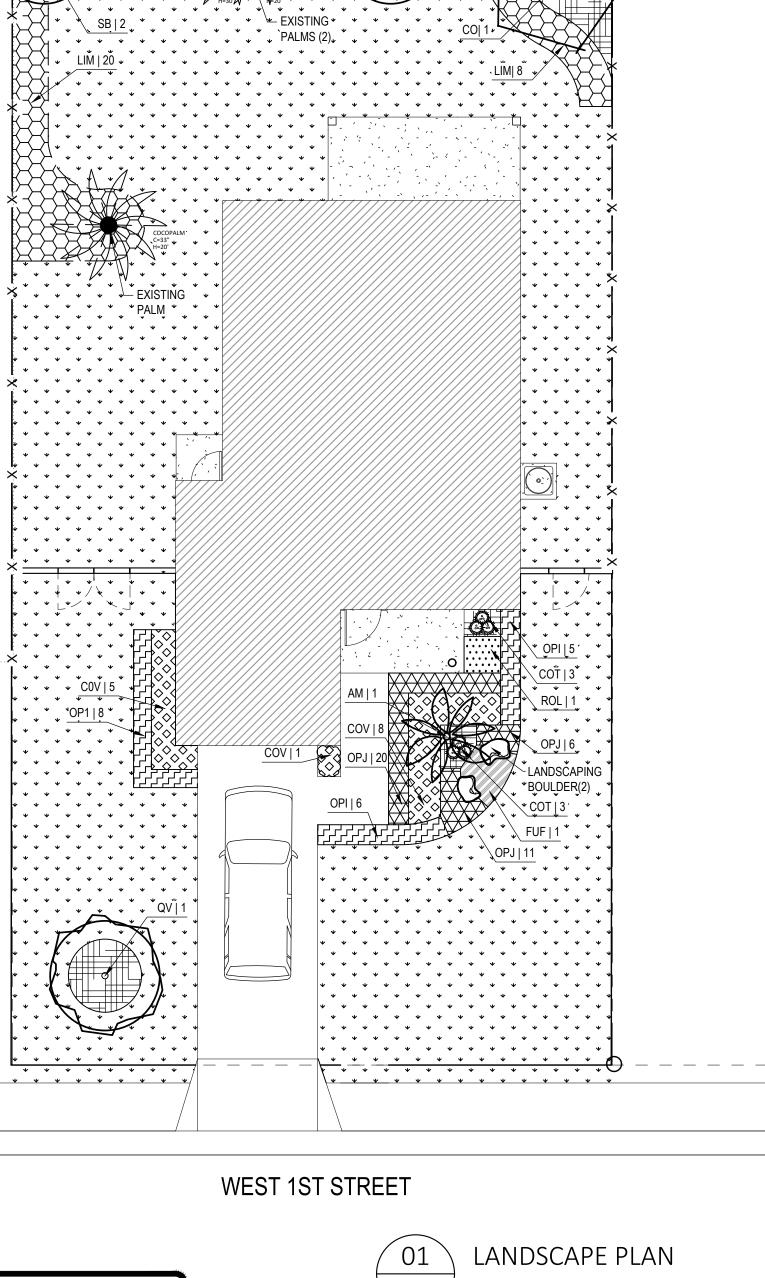



PROTOTYPE SINGLE FAMILY HOME 2 STORY REVISIONS LOT # 673 WEST 1ST STREET, RIVIERA BEACH, FL. 33404 CHECKED BY: DD DQS PN#: 1713 DATE: 06.18.18

SPECIFICATIONS ARE INSTRUMENTS OF SERVICE AND SHALL

REMAIN THE PROPERTY OF D&Q STUDIO LLC. WHETHER THE PROJECT FOR WHICH THEY WERE PREPARED IS EXECUTED OR NOT. THEY ARE NOT TO BE USED, IN WHOLE OR IN PART, IN ANY

MANNER ON OTHER PROJECTS OR EXTENSIONS TO THIS

PROJECT EXCEPT BY WRITTEN AUTHORIZATION OF D&Q STUDIO LLC. ANY SUCH UNAUTHORIZED USE WILL BE SOLELY AT THE

8245 S.W. 42ND STREET MIAMI, FLORIDA 33155 | AA 26003190

STUDIO

USER'S RISK AND D&Q STUDIO LLC WILL BEAR NO RESPONSIBILITY ARISING OUT OF SUCH USE.

LANDSCAPING

SCALE: 1/8" = 1'-0"

PERMIT SET

DANIEL DIAZ

AR # 97839

— ☆ — AR 97839

DATE

FENCE NOTES:

FENCING NOTES:

1. ALL FRAMING TO BE PT WOOD.

LOT #808

- 2. ATTACH COMPOSITE WD TO PT WD WITH 3" COMPOSITE DECK SCREWS COLOR MATCHED.
- 3. COMPOSITE WD BOD: TREX SELECT COMPOSITE DECKING, 1X6, SQUARE EDGE, COLOR TBD. OR APPROVED EQUALS.

EXTG. 4' –

50' - 0"

N90°00'00"E

36' - 0"

LANDSCAPE PLAN

REAR LANAI

EX-2

TWO STORY

RESIDENCE (1st Floor = 756 GSF

2nd Floor = 839 GSF)

FF = 17.33'

EX-1

17.0'

WALK

- NEW CONC

— REFER TO

LANDSCAPE PLAN

GARAGE

(282 GSF)

FF = 17' MAX

10' - 0"

50' - 0"

N90°00'00"E

WEST 1ST STREET

CHAIN LINK

17' - 8"

SLOPE

GRADE

13' - 8"

NEW CONC. DRIVEWAY 6", **CONTROL JOINTS**

@ 5' OC

SLOPE

GRADE

LANDSCAPE PLAN

EXTG. DRIVEWAY CURB -

CUT AND APRON

16.05

7' - 0"

SIDE SETBACK

17.4'

EXTG. 4' —

FENCE

ROOF ABOVE +

NEW 4' FENCE

AND GATES

NEIGHBOR -

LINK FENCE

EXTG. 4' CHAIN

CHAIN LINK

LOT #809

OVERHEAD

ELECTRICAL

SIDE


SETBACK

7' - 8"

SLOPE

GRADE

+++

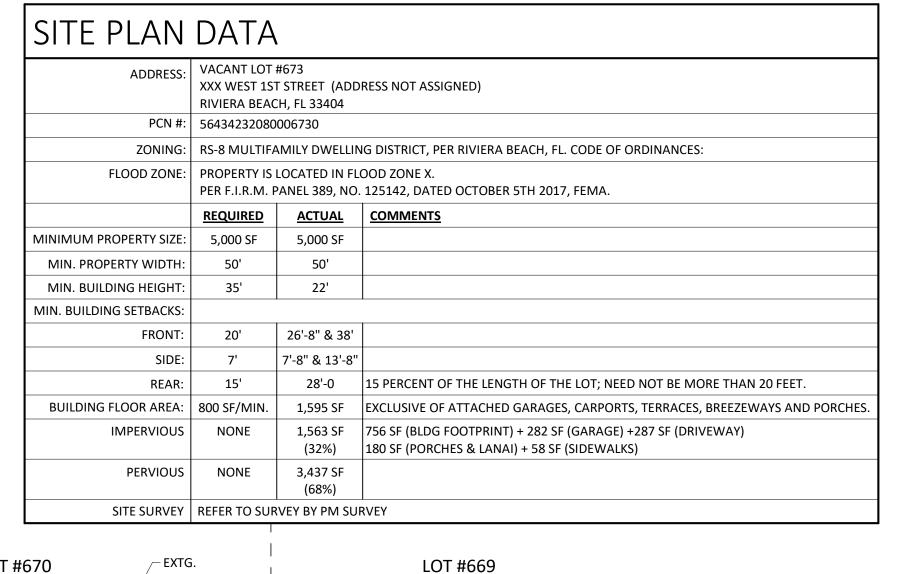

EASEMENT

LOT #671

- NEIGHBOR EXTG. 4'

CHAIN LINK FENCE

ROOF ABOVE

— CONDENSER UNIT ON


ANTI-THEFT CAGE AND


PAD LOCK, BOD: AC-

GUARD #5ULD4

NEW 4' HIGH


FENCE AND GATE

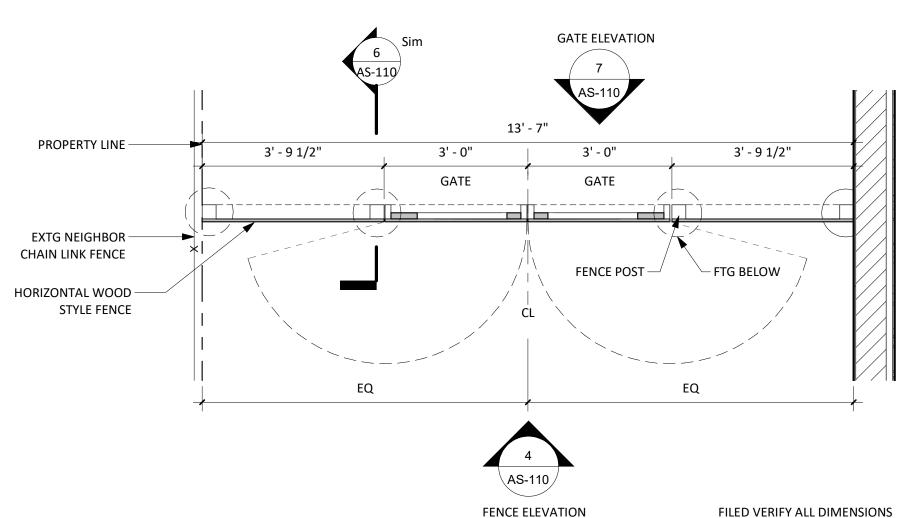


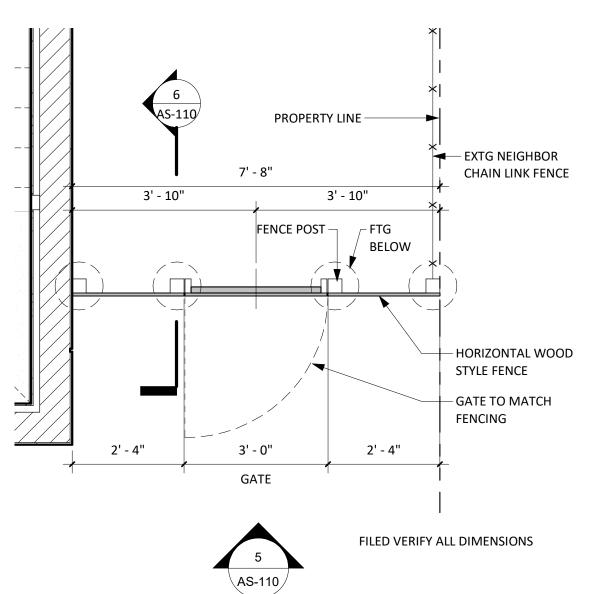


FENCE PLAN WEST AS-110 1/2" = 1'-0"

3 FENCE PLAN EAST AS-110 1/2" = 1'-0"

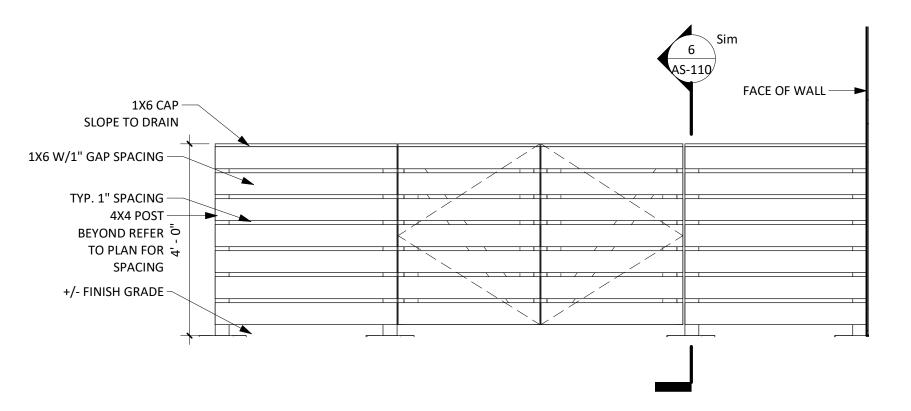

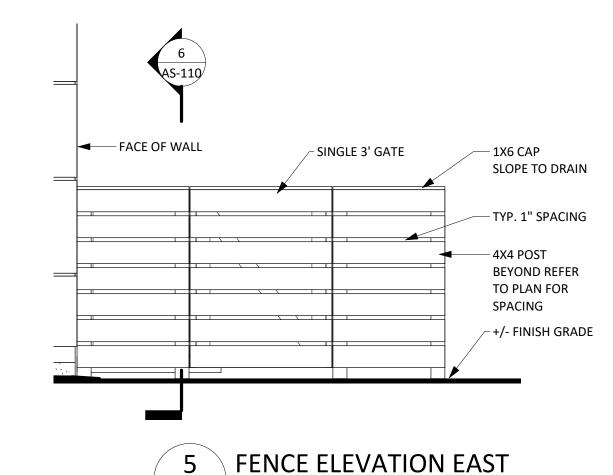

4 FENCE ELEVATION WEST AS-110 1/2" = 1'-0"

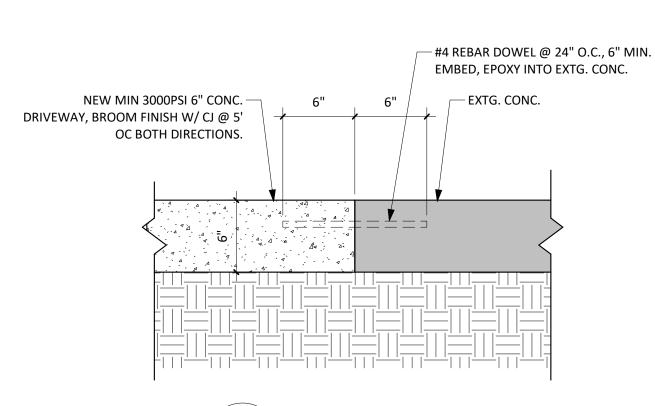



AS-110 1/2" = 1'-0"

10 DETAILS - SITE CONC AS-110 1 1/2" = 1'-0"

DANIEL DIAZ

AR 97839

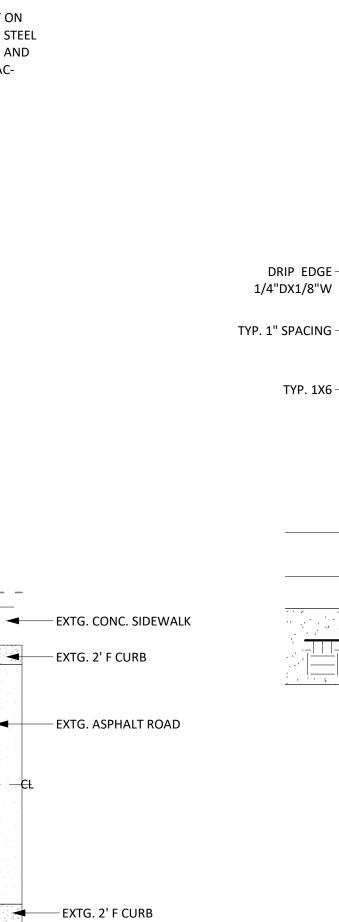

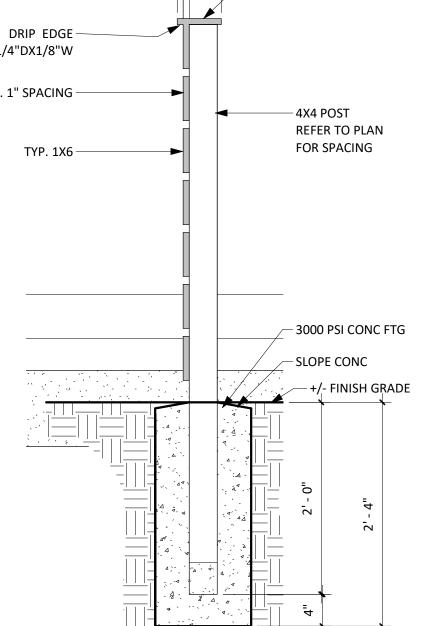


1' - 0"

TYP. FENCE SECTION - WD

AS-110 1" = 1'-0"

SLOPE TO DRAIN

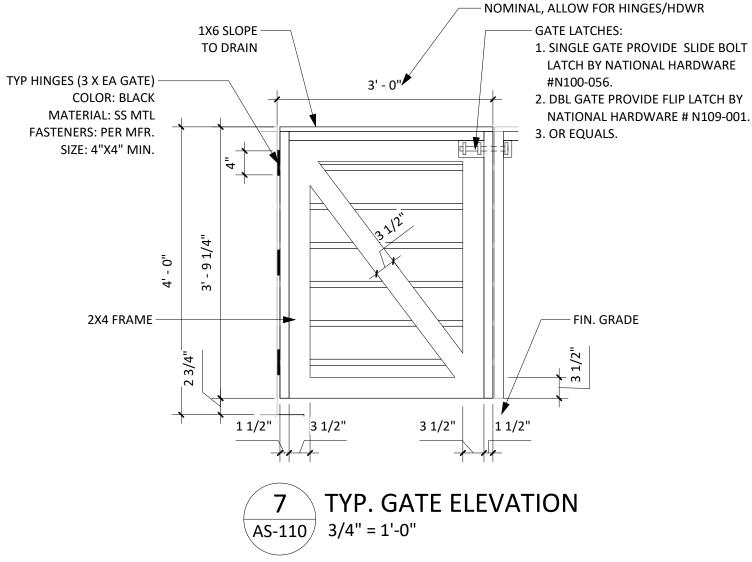




PROTOTYPE SINGLE FAMILY HOME 2 STORY DATE DRAWN BY: PROJECT SITE ADDRESS: Vacant Lot #673 West 1st Street Riviera Beach, FL 33404 Checker DQS PN#: 1713 DANIEL DIAZ AR# 97839 06.22.18

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SITE PLAN & **FENCE DETAILS**

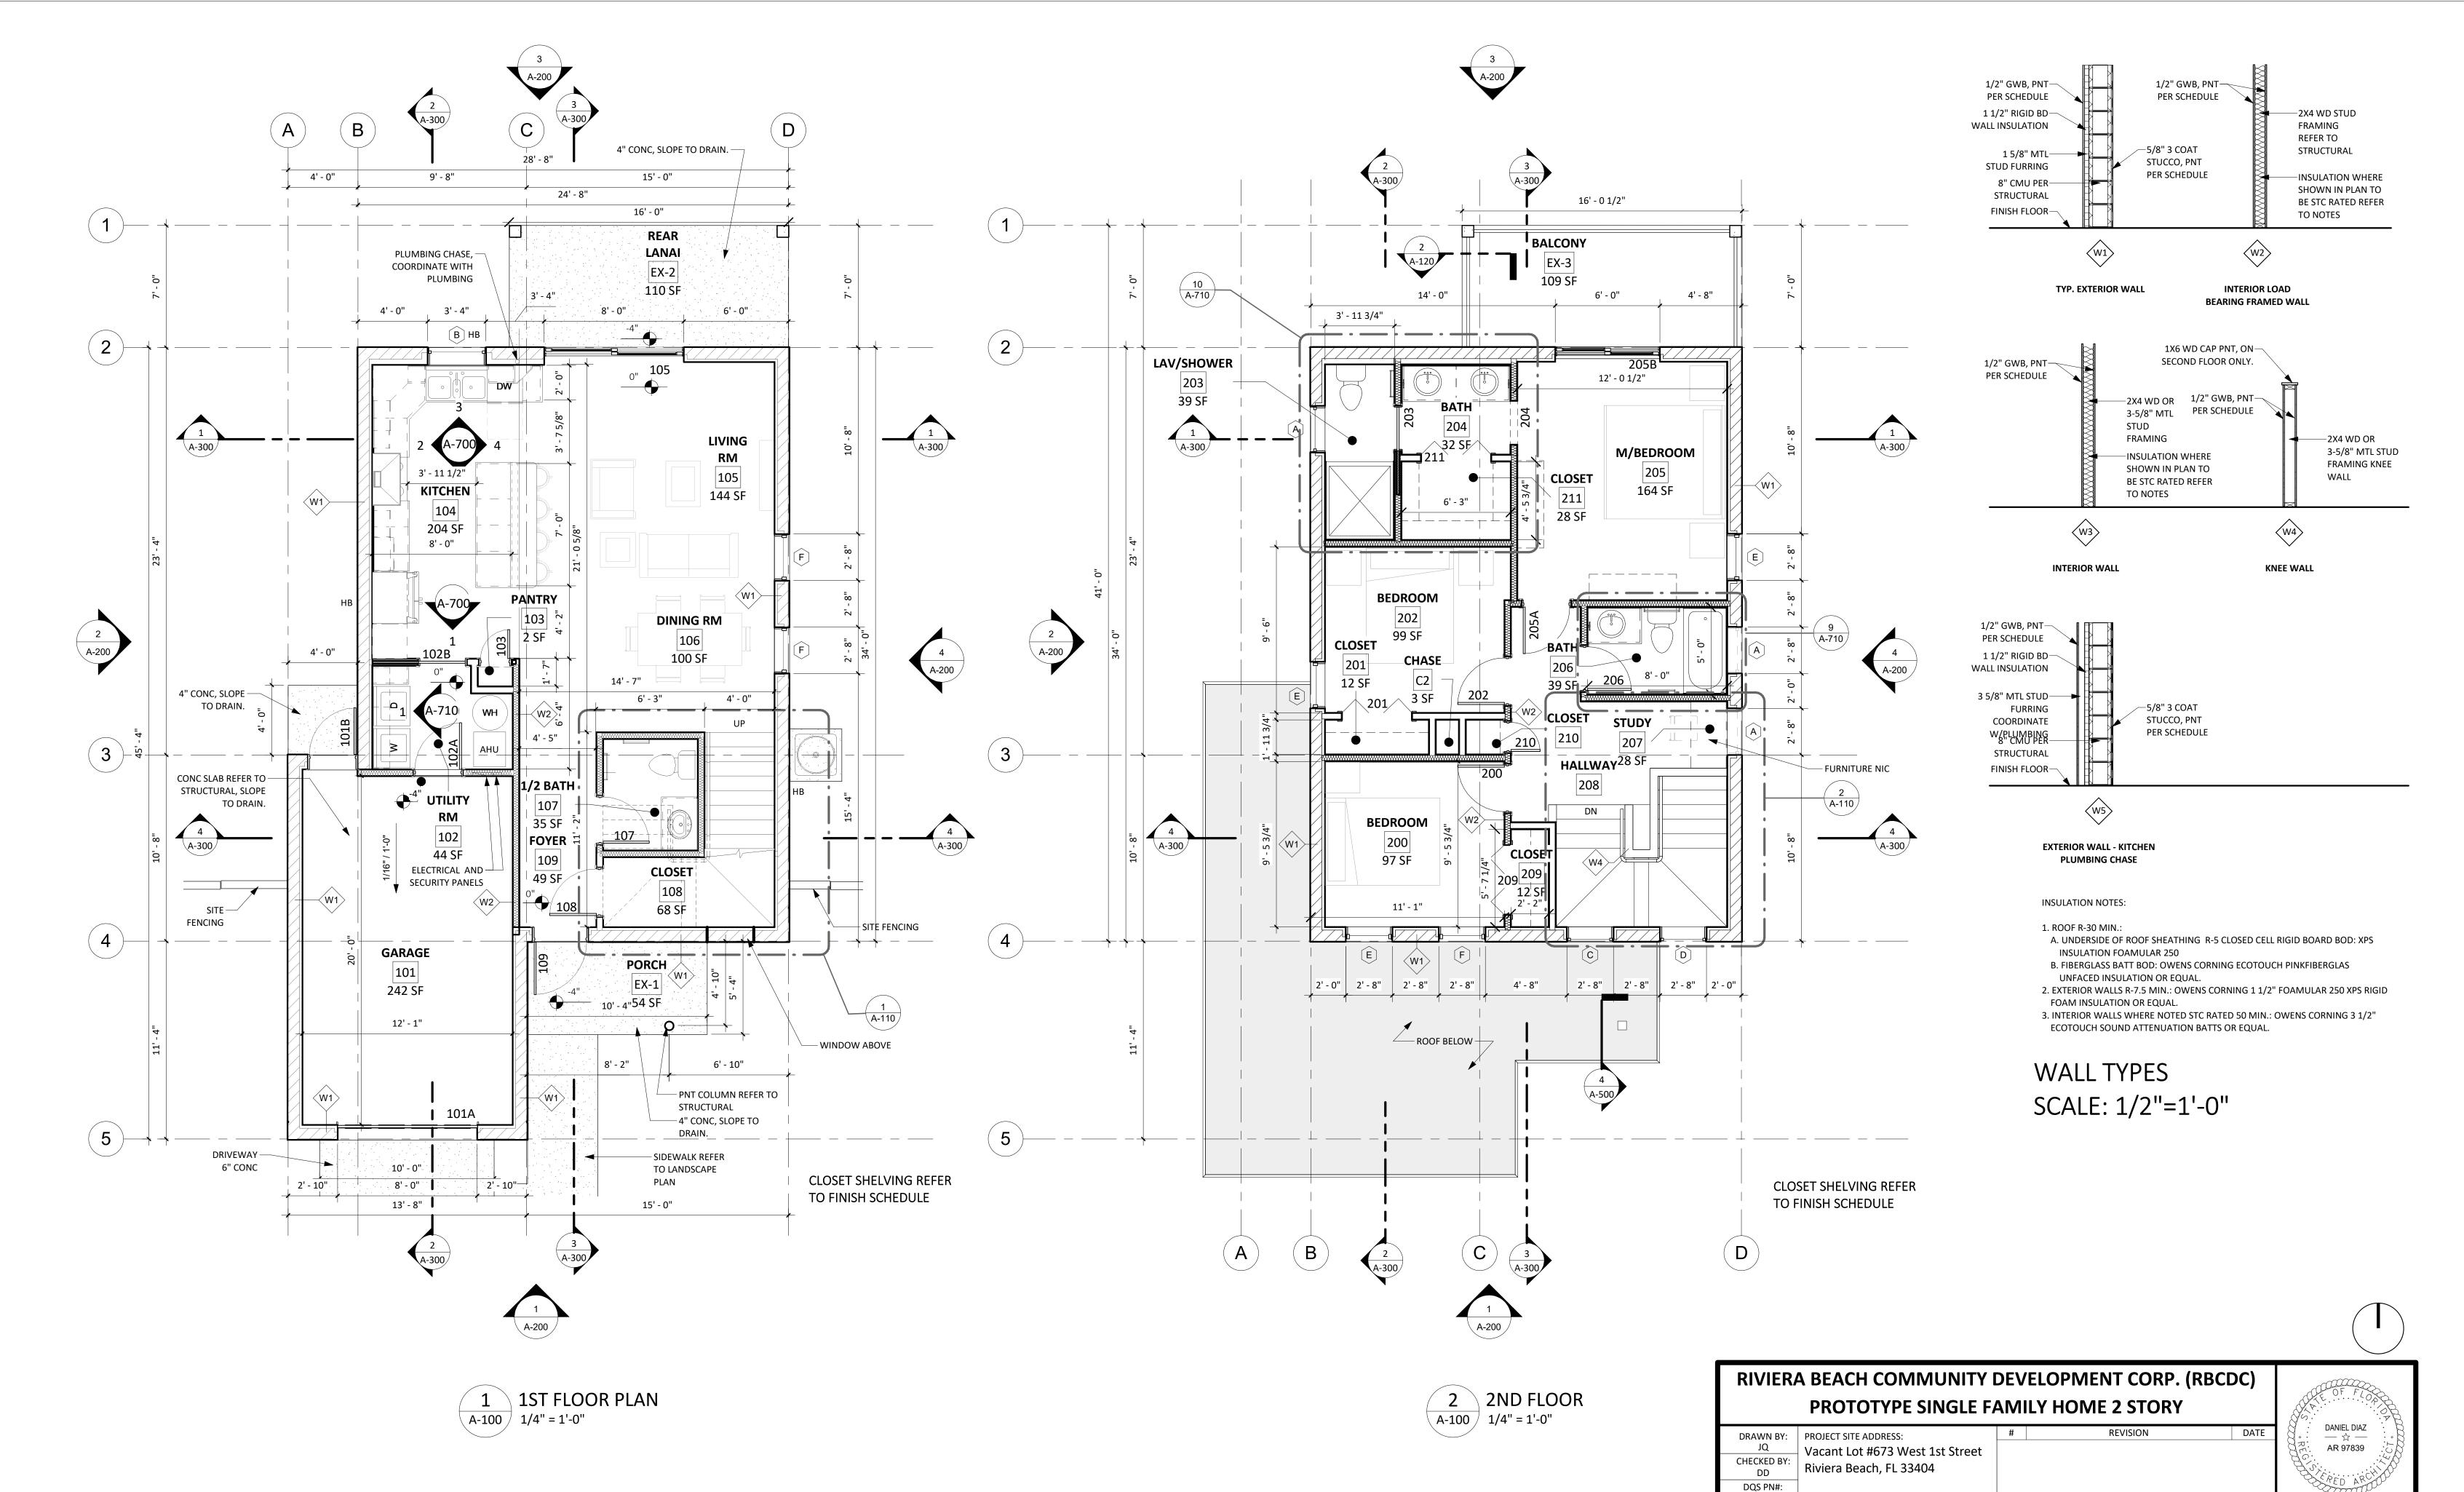


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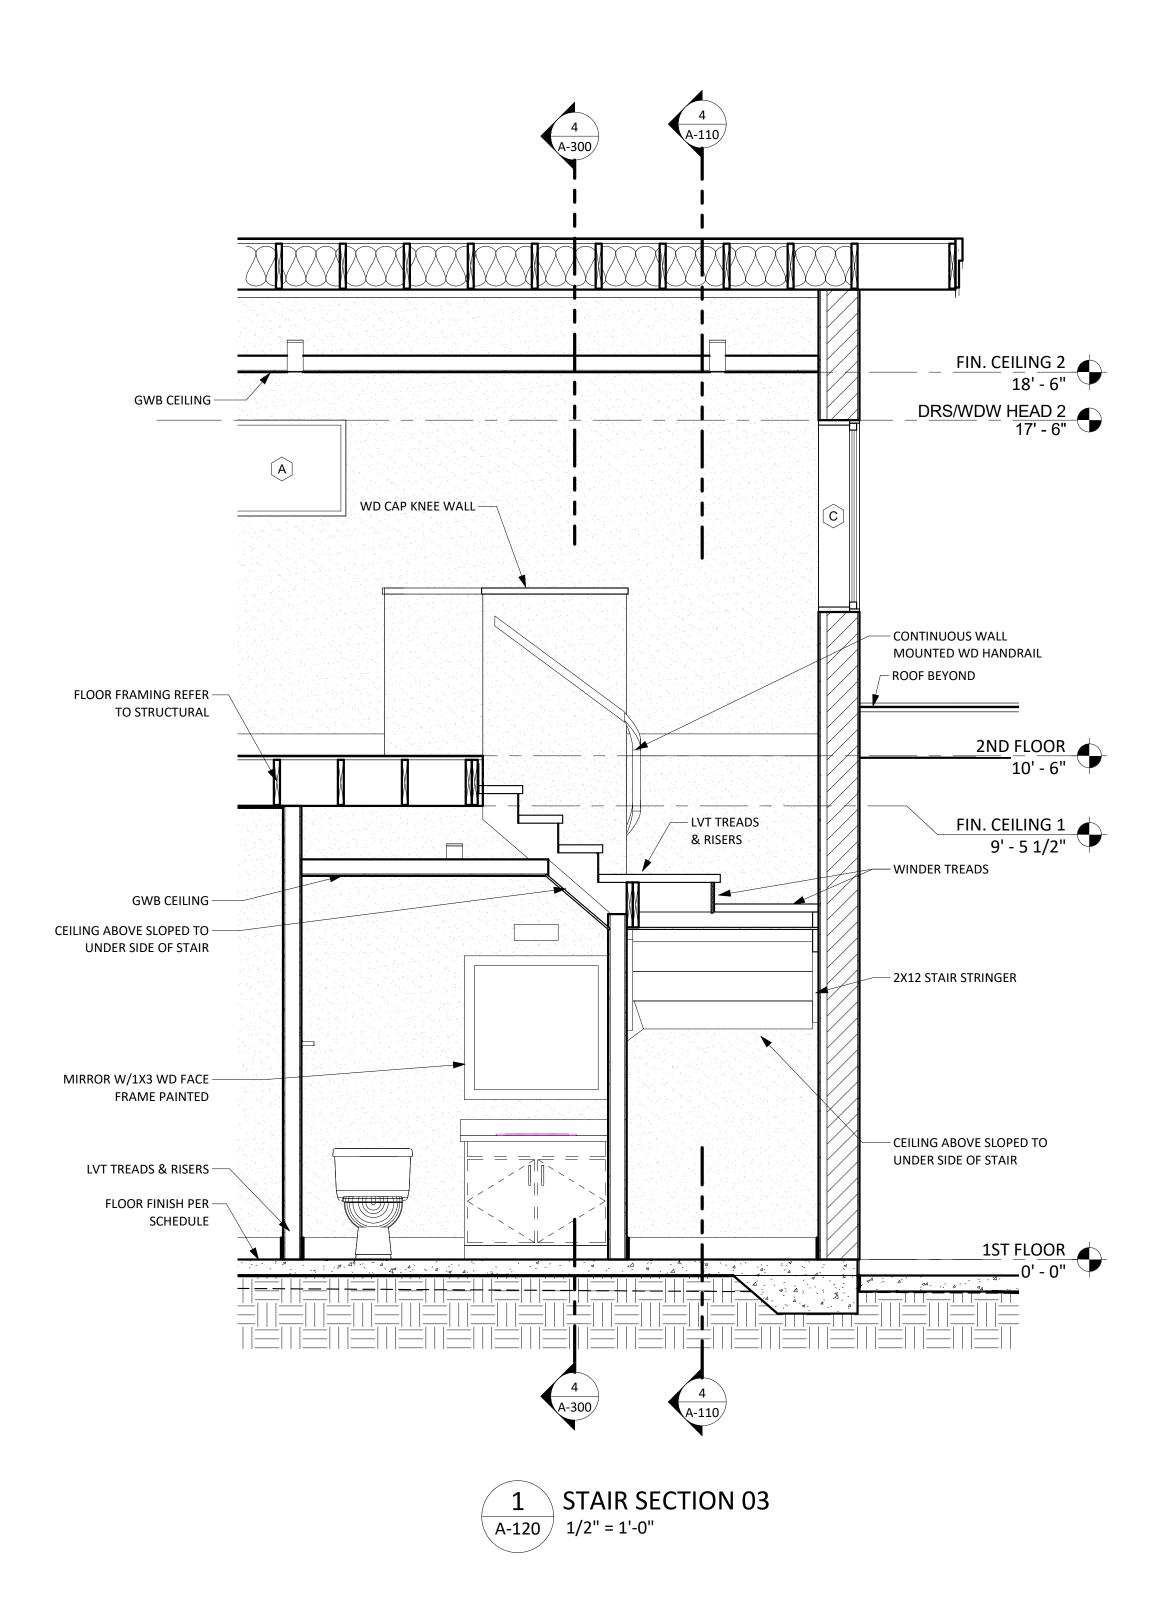
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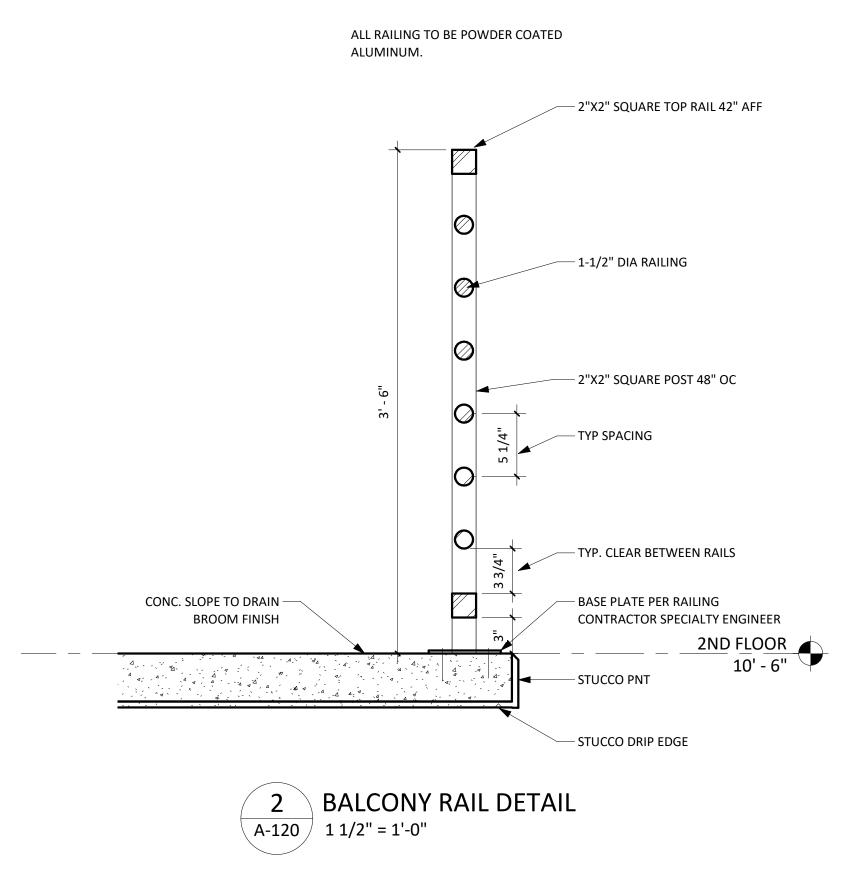
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DANIEL DIAZ


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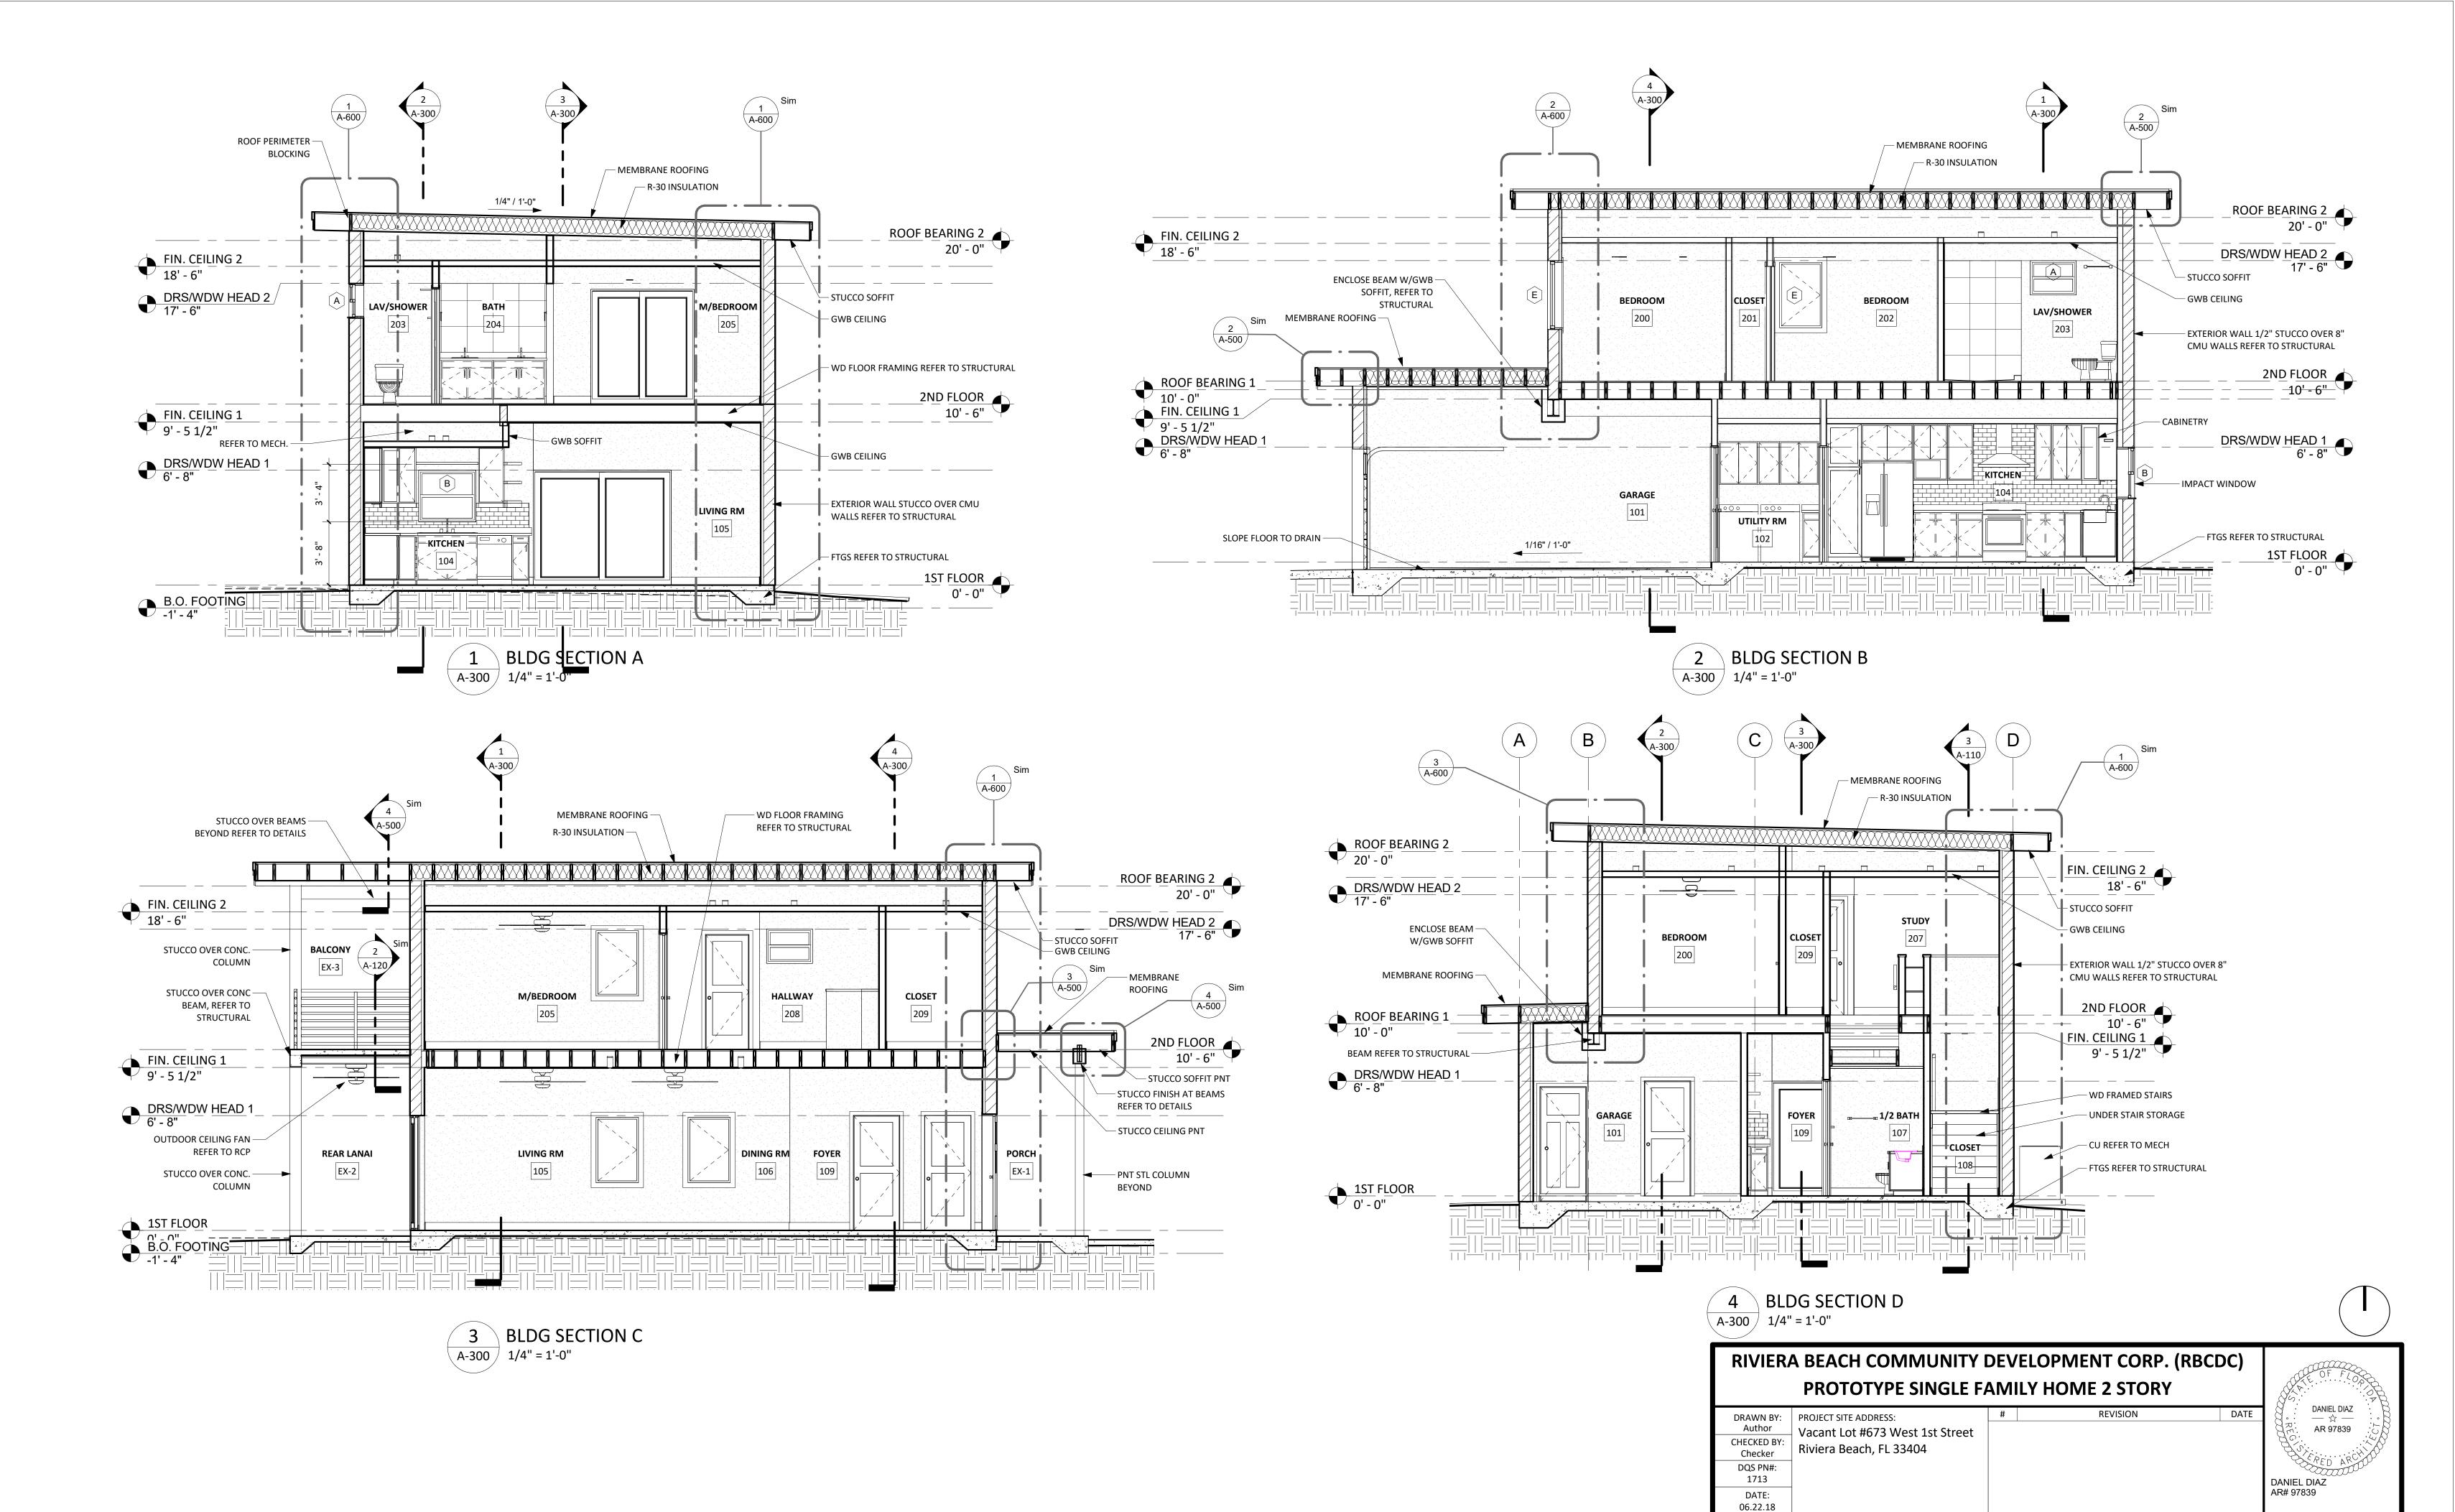






	PROTOTYPE SINGLE FA	AIVIIL I	IOMIL 2 STORT		S. PANIEL DIAZ
DRAWN BY: Author CHECKED BY:	PROJECT SITE ADDRESS: Vacant Lot #673 West 1st Street	#	REVISION	DATE	DANIEL DIAZ RR: → ☆ → ··· RR: AR 97839
Checker	Riviera Beach, FL 33404				
DQS PN#: 1713					DANIEL DIAZ
DATE: 06.22.18					AR# 97839
S	LICENSE AA 26003190 8245 S.W. 42ND STREET MIAMI, FLORIDA 33155 P:(786) 239-1322 F:(305) 223-0574 WWW.D-Q-S.COM	STAI	R SECTIONS		PERMIT SET

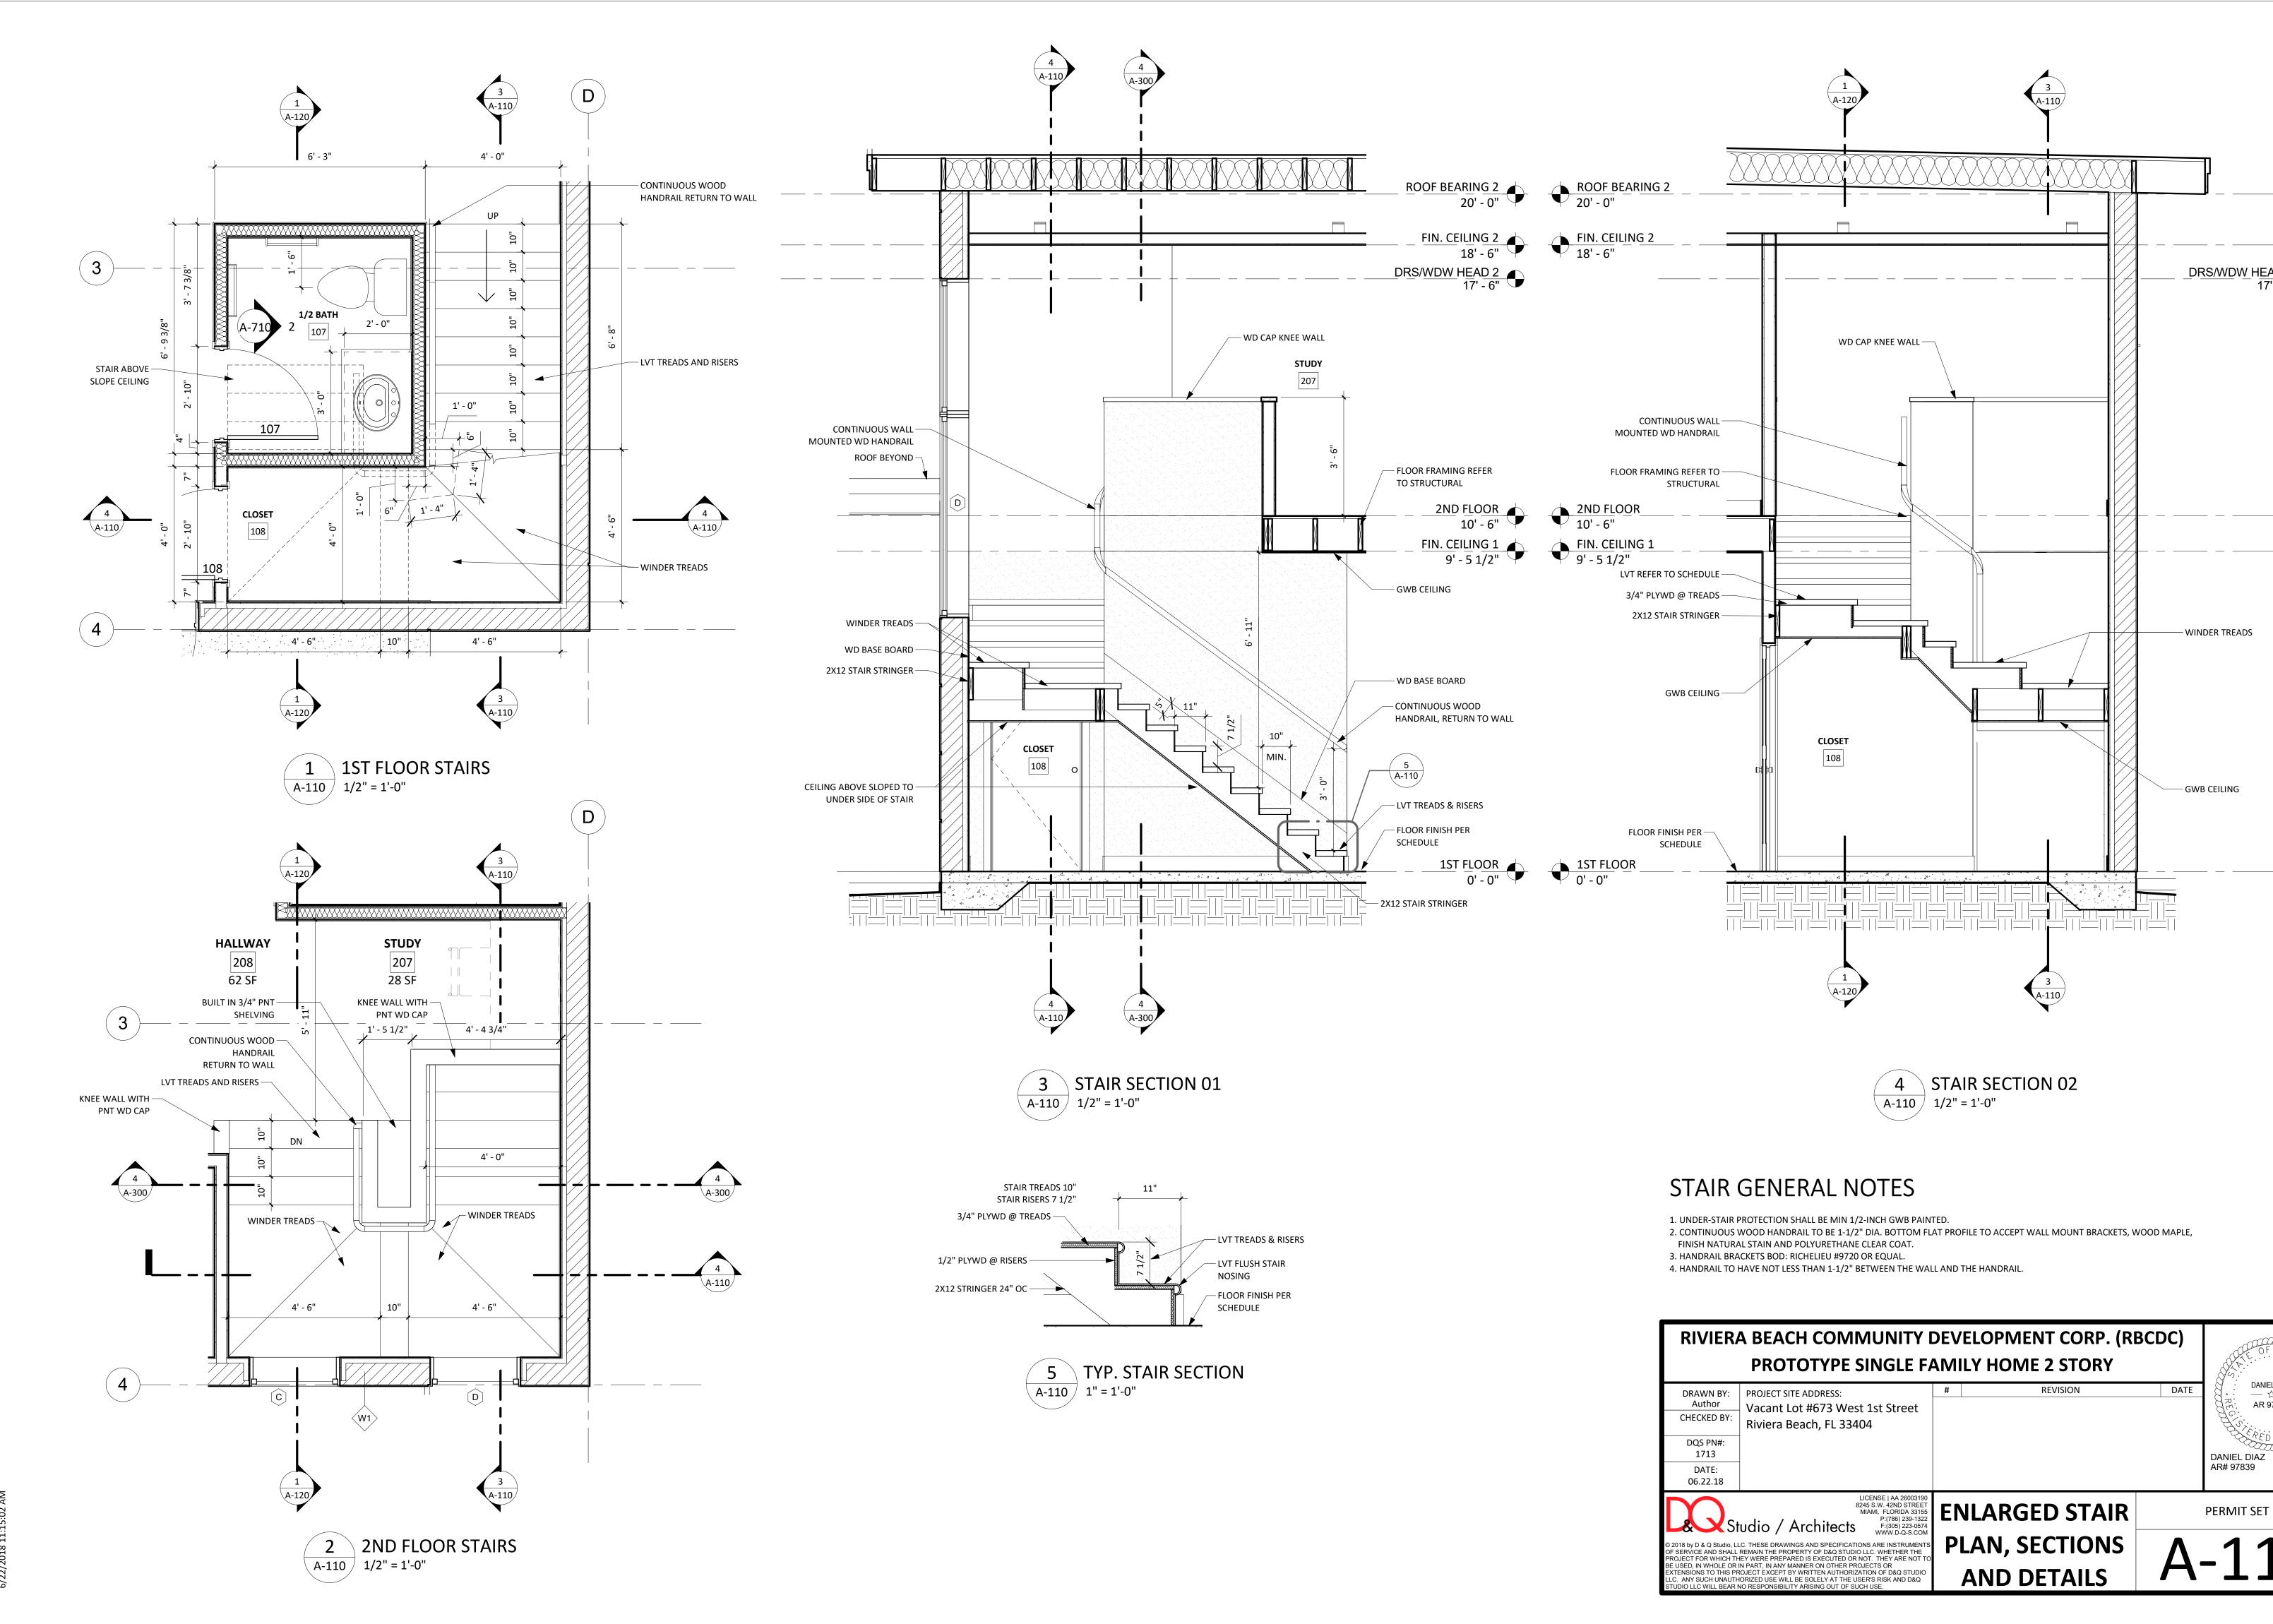

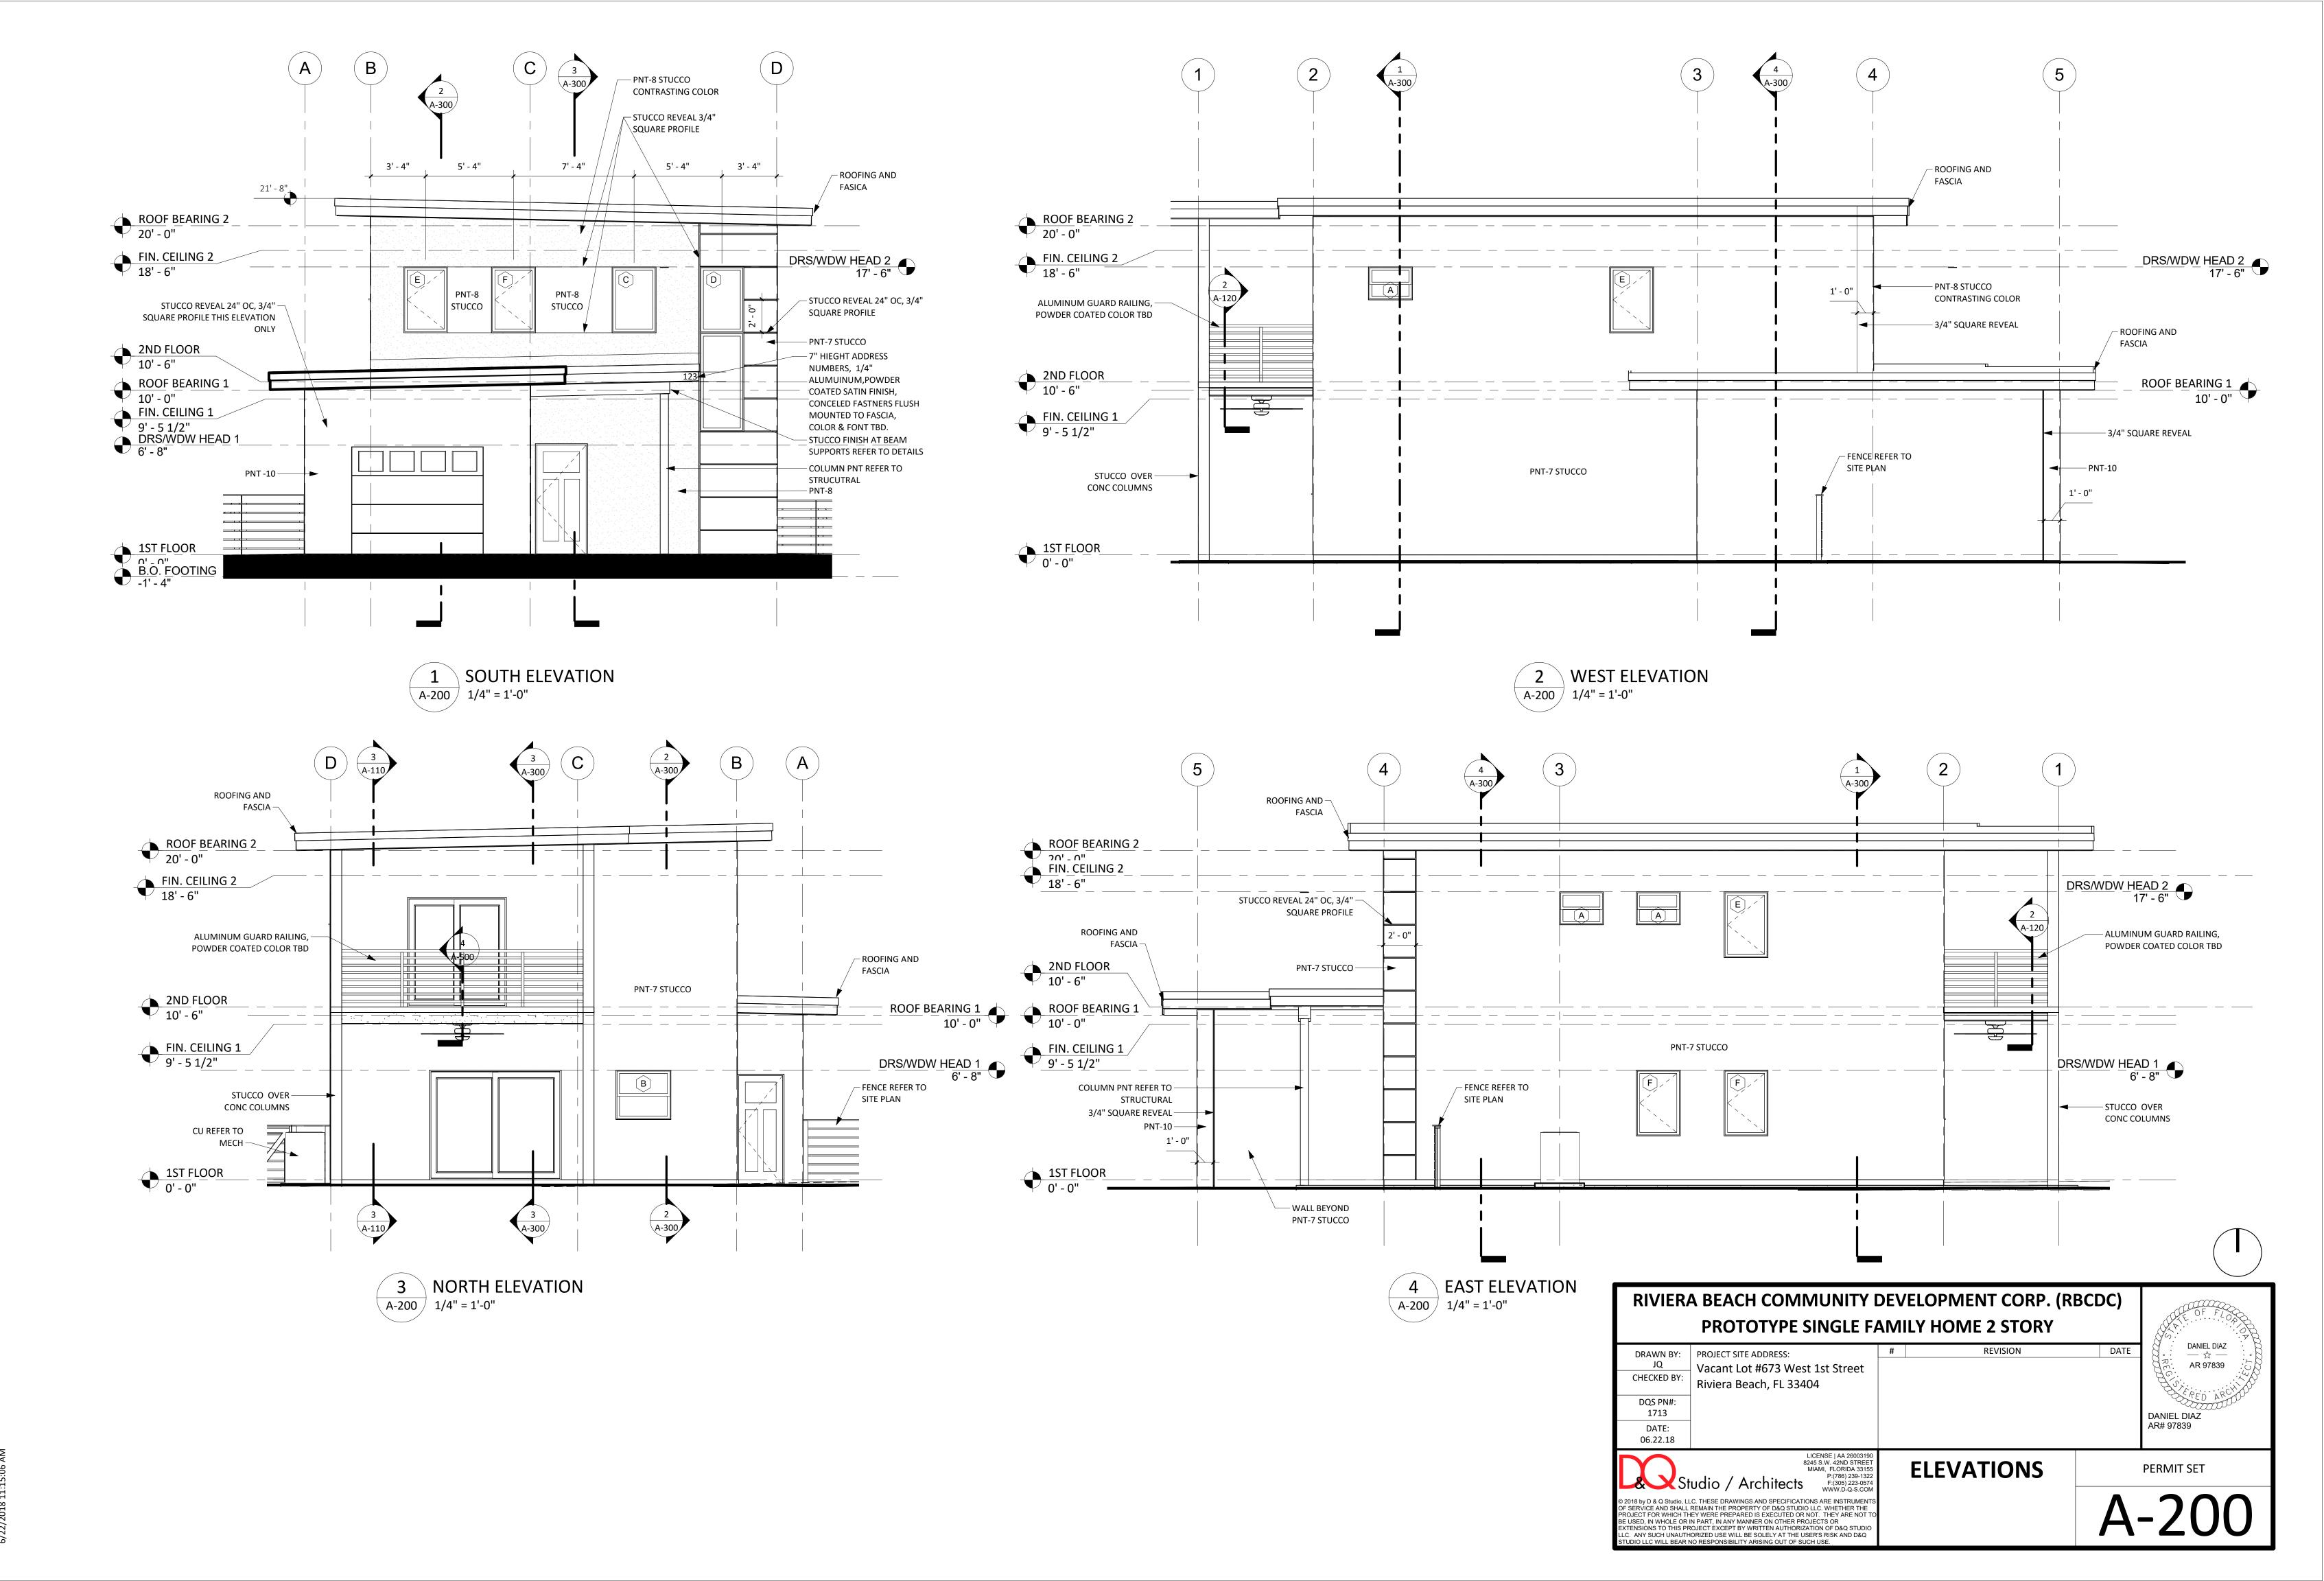

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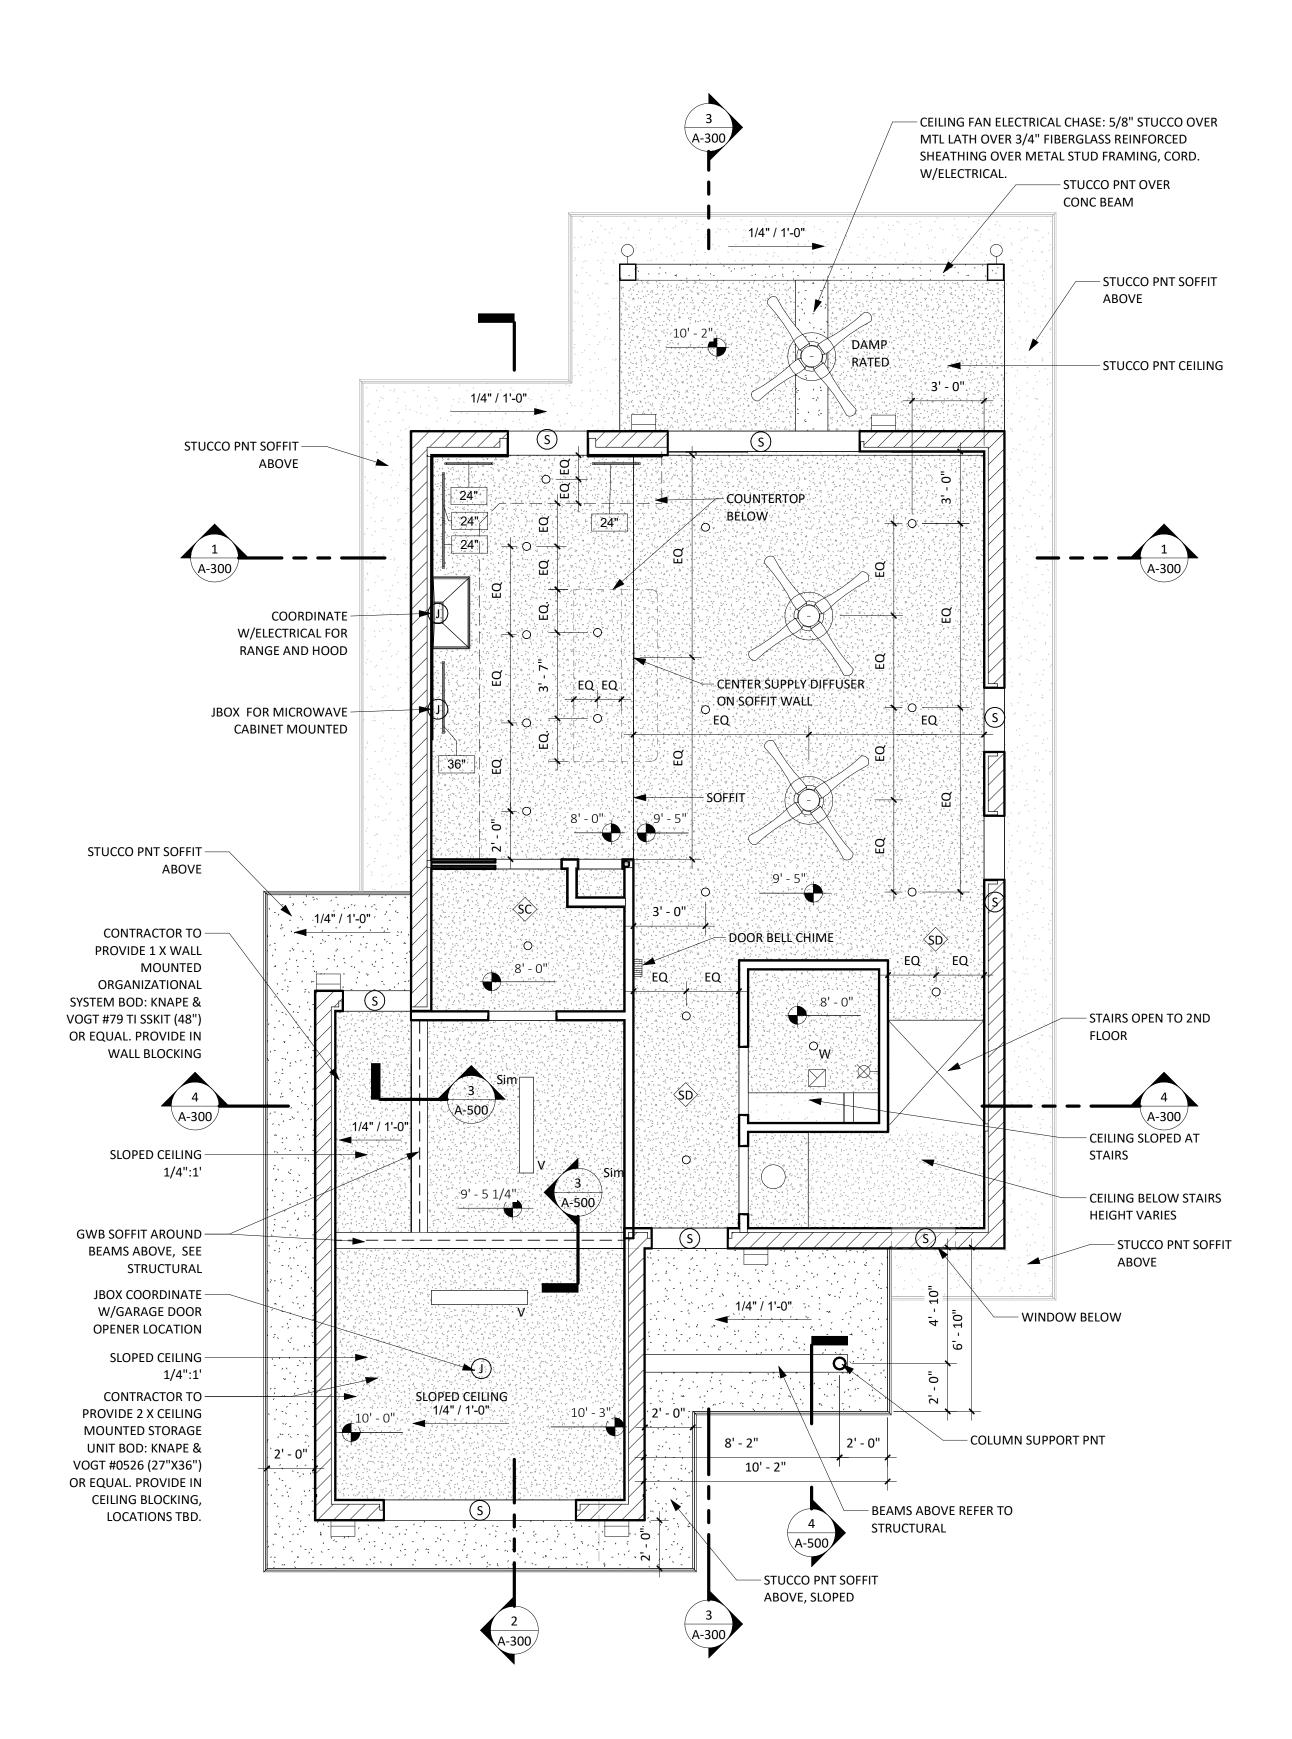
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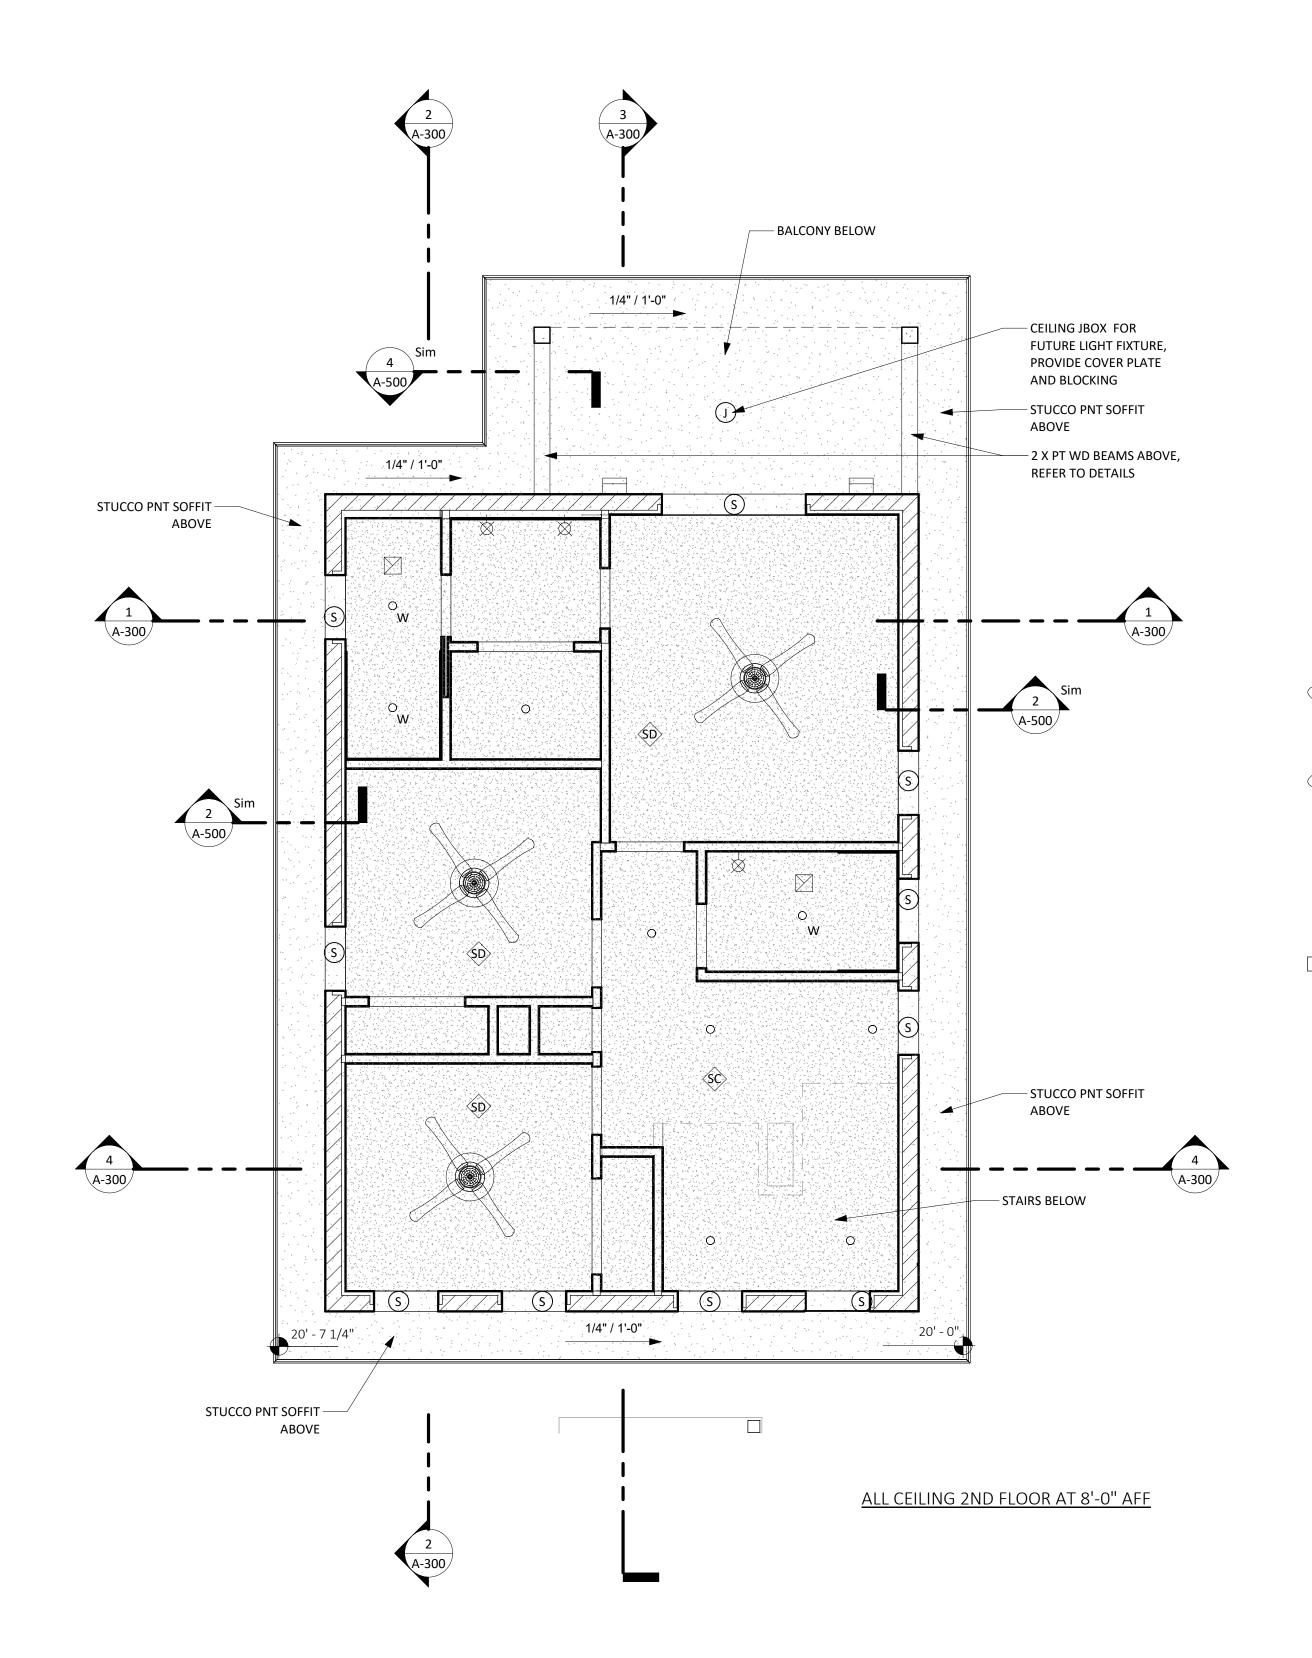
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P:(786) 239-132 F:(305) 223-057 BUILDING

SECTIONS



RCP PLAN 1ST FLOOR A-400 / 1/4" = 1'-0"



2 RCP PLAN 2ND FLOOR A-400 / 1/4" = 1'-0"

RCP LEGEND:

CEILING FINISHES:

GARAGE.

GWB CEILINGS, TYP. 1/2" GYPSUM WALL BOARD CEILINGS EXPECT USE 5/8" IN




EXTERIOR STUCCO CEILINGS/SOFFITS

INTERIOR LIGHT FIXTURES:

LIGHT FIXTURES NOTES: 1. ALL LIGHT FIXTURE BASIS OF DESIGN (BOD) MFR. TO BE PROGRESS LIGHTING UNO. 2. ALL FIXTURES TO BE IC RATED IN CAVITIES W/INSULATION




CAN LIGHT: MODEL #: P800004 W = BATH/SHOWER RATED

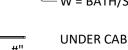

UNDER CABINET STRIP LIGHT, SEE PLAN FOR LENGTHS

24" LENGTH USE MODEL #: P700003-028-30 36" LENGTH USE MODEL #:P700004-028-30

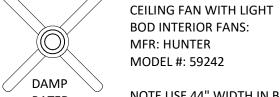

BOD INTERIOR FANS: MFR: HUNTER MODEL #: 59242

NOTE USE 44" WIDTH IN BEDROOMS AND 54" WIDTH IN GREAT ROOM.

- DAMP RATED CEILING FAN IN OUTDOOR LOCATIONS



SURFACE MOUNTED LIGHT, VAPOR PROOF MODEL #: PCIVT-LED-4-35K

BATH VANITY LIGHTS, WALL MOUNTED MFR.: MOEN, 1/2 BATH FIRST FLOOR USE MODEL #: YB2262BN, BRANTFORD CHROME

EXTERIOR LIGHT FIXTURES:

EXTERIOR WALL MOUNTED LIGHT FLOOD LIGHT MODEL #: P563001-143-30K, 3IN LED WALL MOUNT UP/DOWN CYLINDER

ALL OTHERS USE MODEL #: YB2263CH, BRANTFORD CHROME

EXTERIOR WALL MOUNTED LIGHT MODEL #: P5203-31, TWO-LIGHT ADJUSTABLE SWIVEL FLOOD LIGHT, W/ CREE 150W EQUIVALENT (3000K) PAR38 LED BULBS

MISCELLANEOUS:


SMOKE ALARM. LISTED IN ACCORDANCE WITH UL 217.

COMBINATION SMOKE AND CARBON MONOXIDE ALARM. LISTED IN ACCORDANCE WITH UL 217 AND UL 2034.


SECURITY SYSTEM LOCATIONS, CONTRACTOR TO COORDINATE W/SECURITY VENDOR AND OWNER ON SECURITY SYSTEM AT ALL EXTERIOR WINDOWS AND DOORS. PROVIDE CONDUIT WITH PULL STRINGS ONLY TO LOCATIONS INDICATED ON PLANS.


EXHAUST FAN BATHROOM


WIRED DOOR BELL BOD: HEATH ZENITH (OR APPROVED EQUAL) WIRED PUSH BUTTON #SL-604 WIRED DOOR CHIME #SL-2735 TRANSFORMER #SL-122

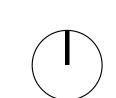

RIVIER	A BEACH COMMUNITY I PROTOTYPE SINGLE FA	BCDC)	OF FLOOR		
DRAWN BY: Author CHECKED BY: Checker DQS PN#: 1713 DATE: 06.22.18	PROJECT SITE ADDRESS: Vacant Lot #673 West 1st Street Riviera Beach, FL 33404	#	REVISION	DATE	DANIEL DIAZ AR 97839 PED AR DANIEL DIAZ AR# 97839
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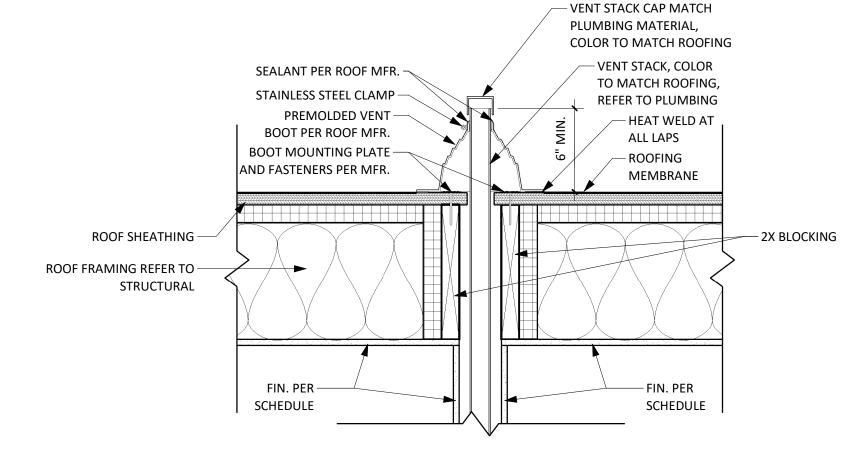


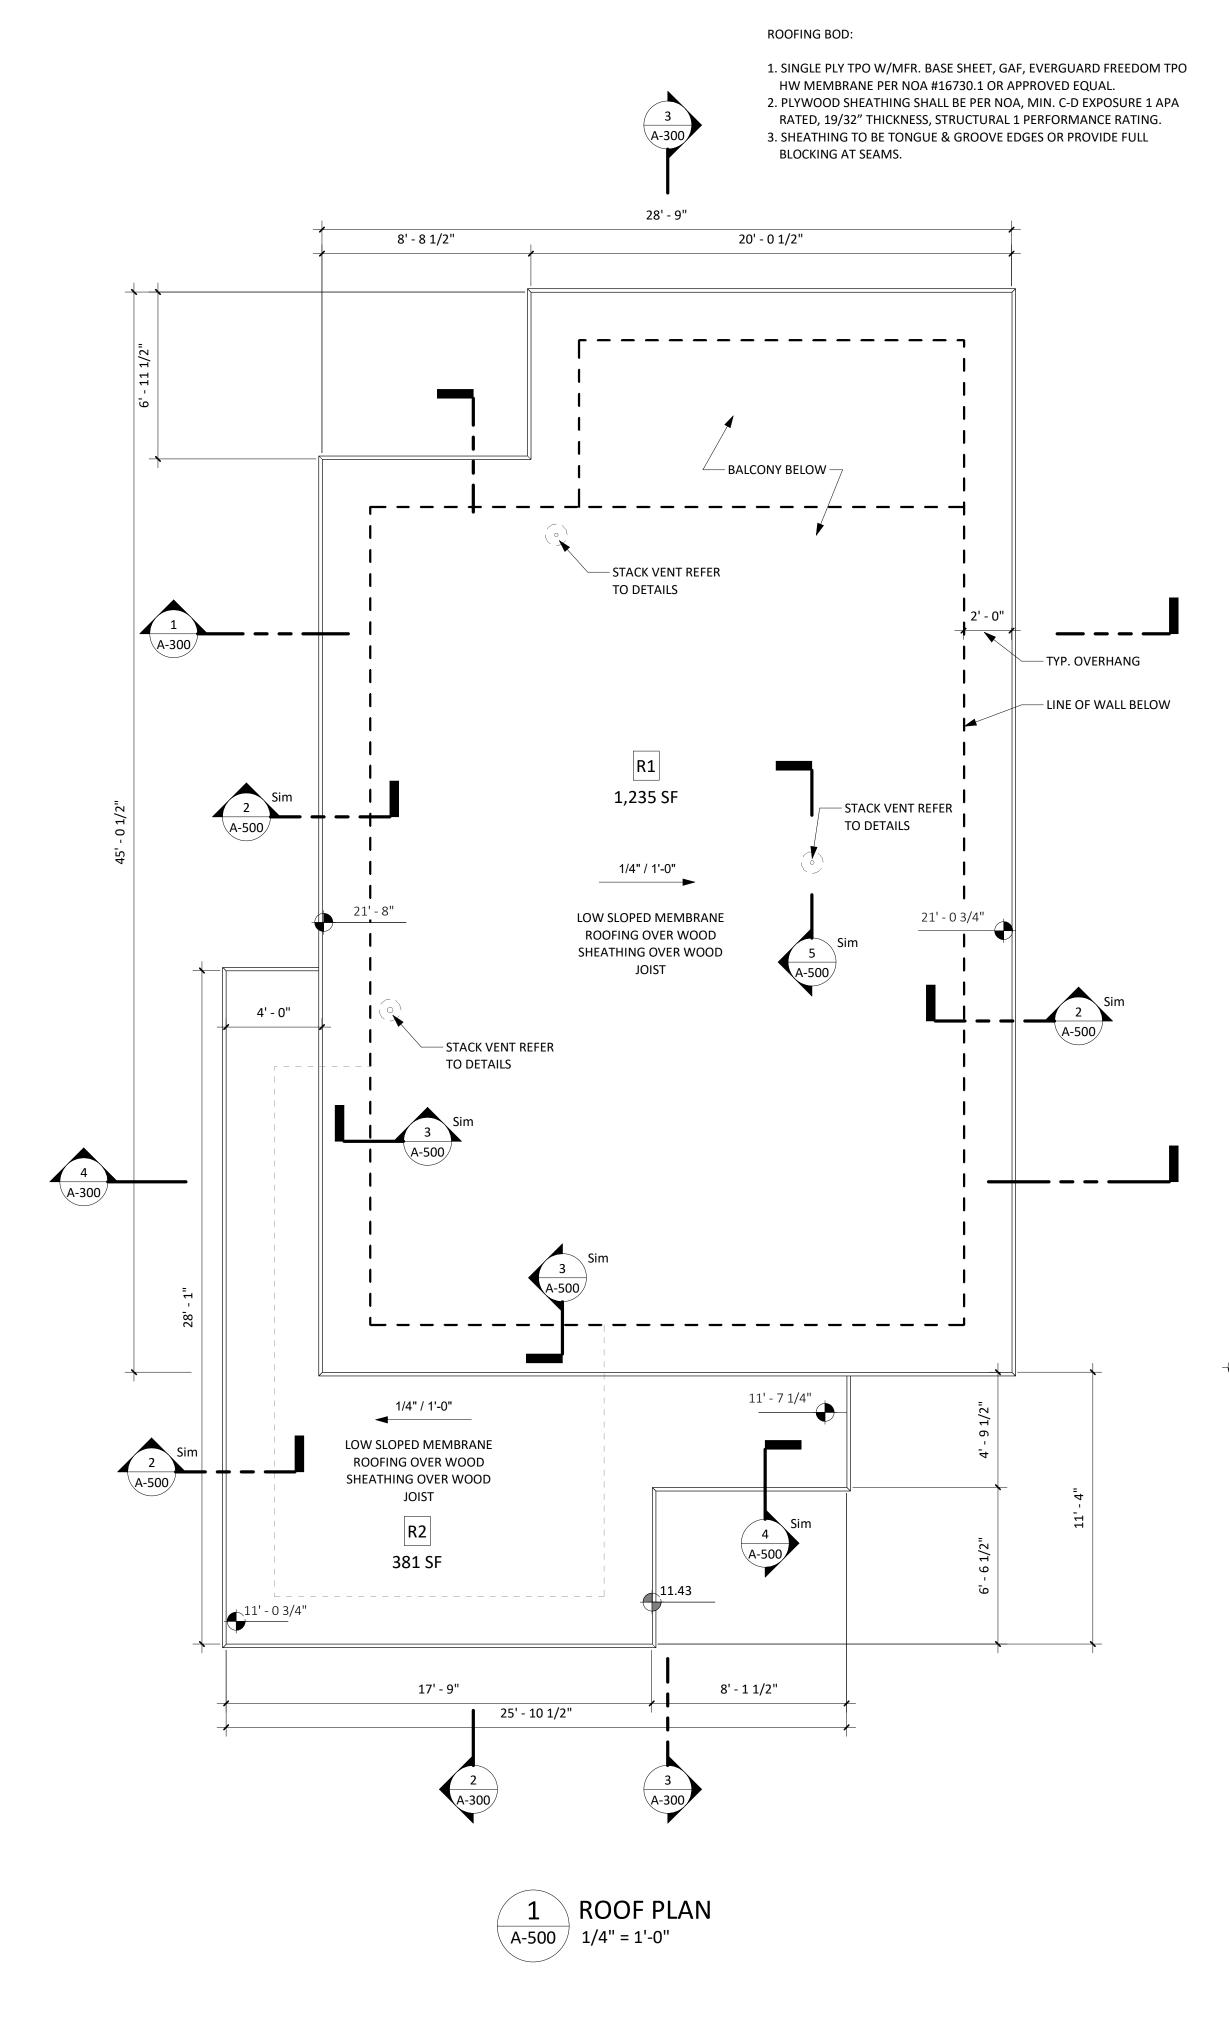


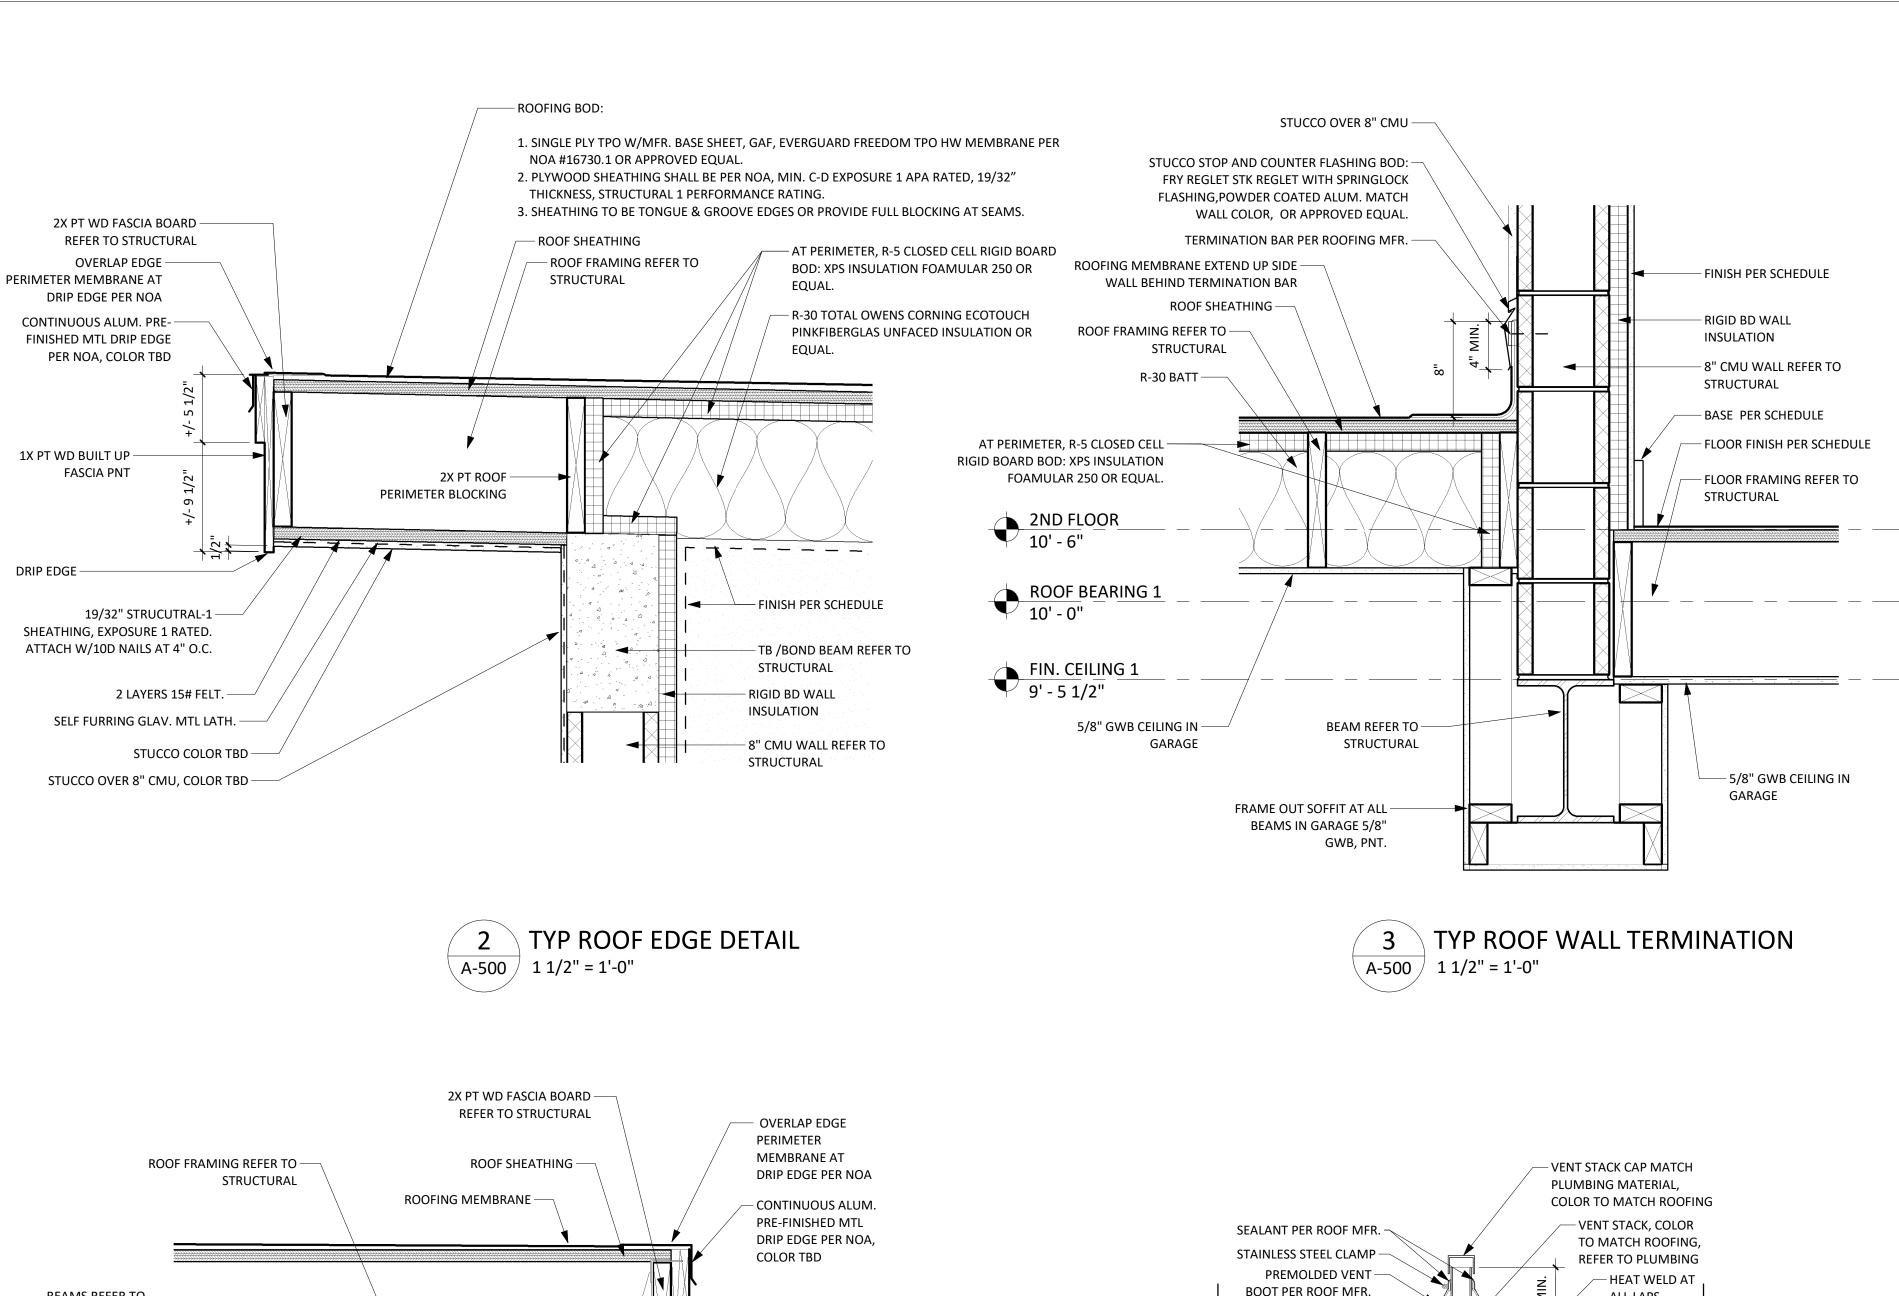


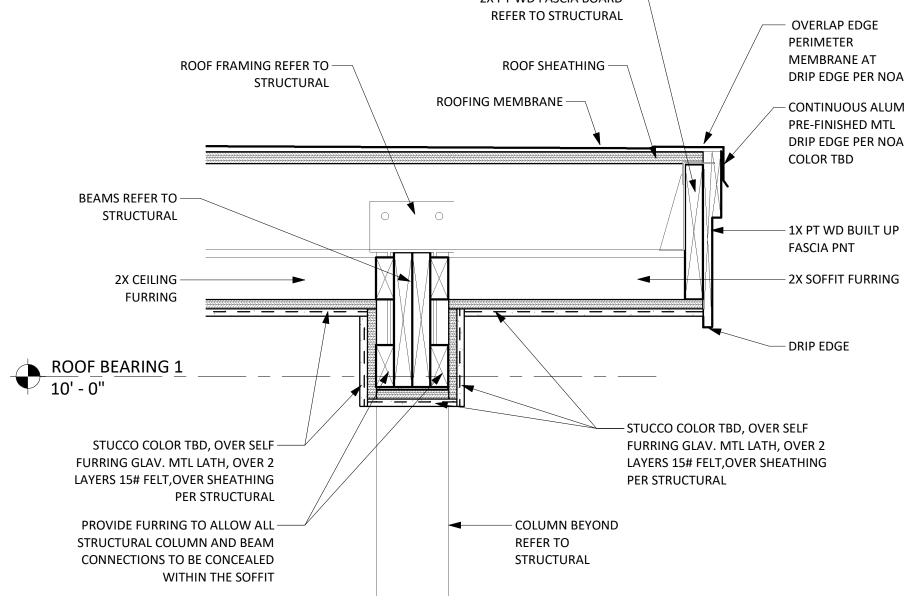PORCH/BALCONY BEAM SUPPORT DETAIL

A-500 1 1/2" = 1'-0"



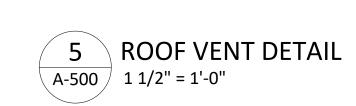


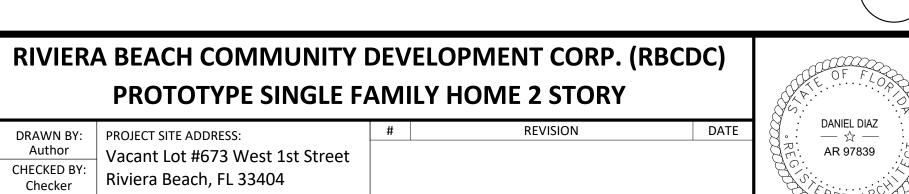



PROTOTYPE SINGLE FAMILY HOME 2 STORY DRAWN BY: PROJECT SITE ADDRESS: Vacant Lot #673 West 1st Street CHECKED BY Riviera Beach, FL 33404 Checker DQS PN#: 1713 DANIEL DIAZ AR# 97839 DATE: 06.22.18

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WALL SECTION - C A-600 3/4" = 1'-0"

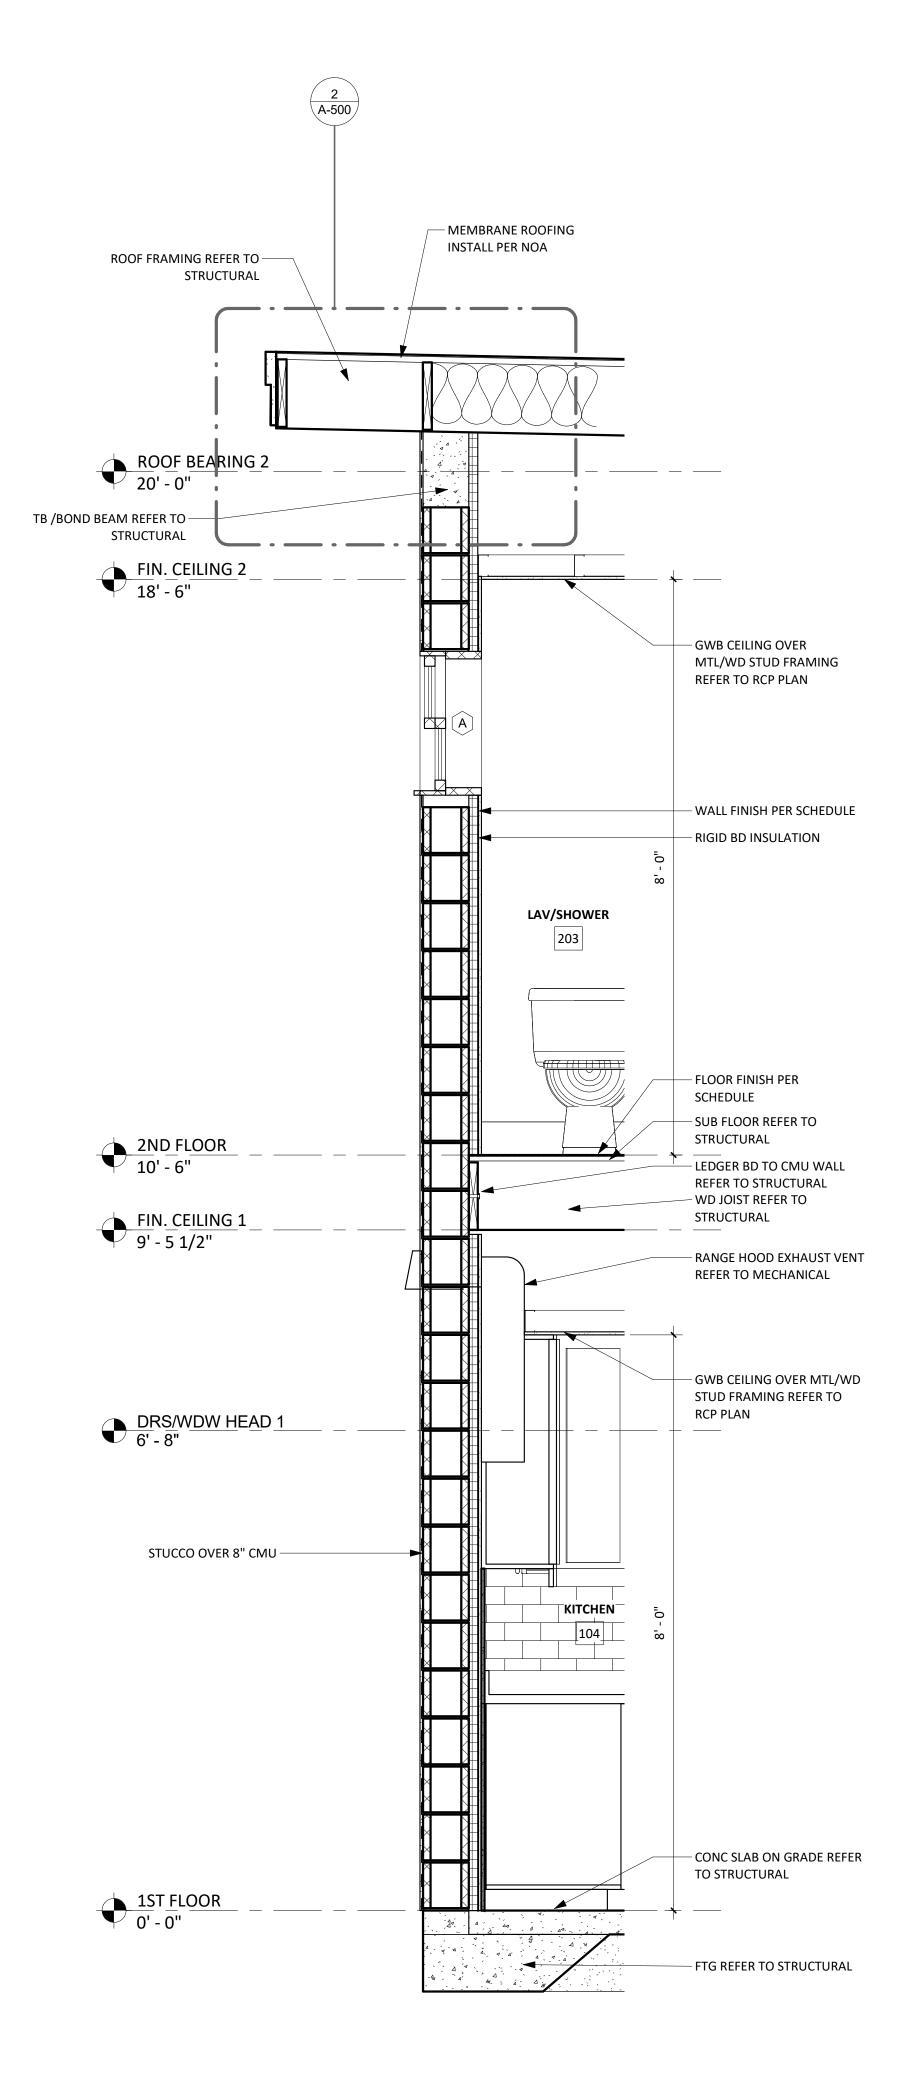


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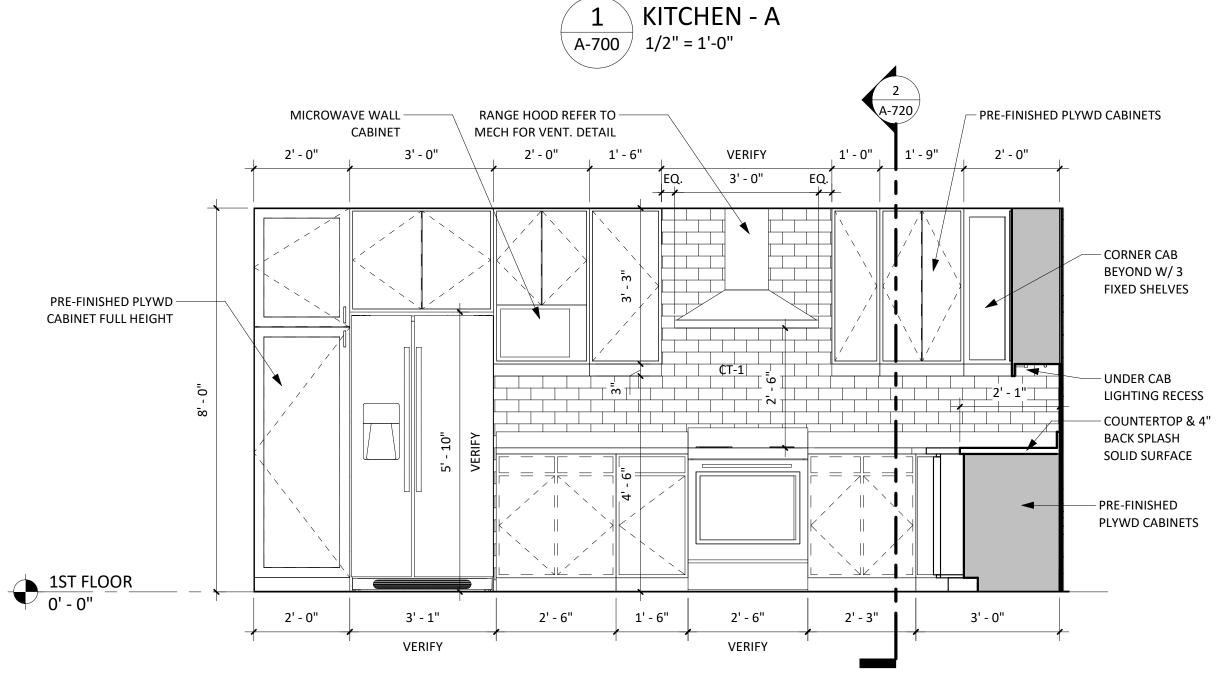
AR 97839

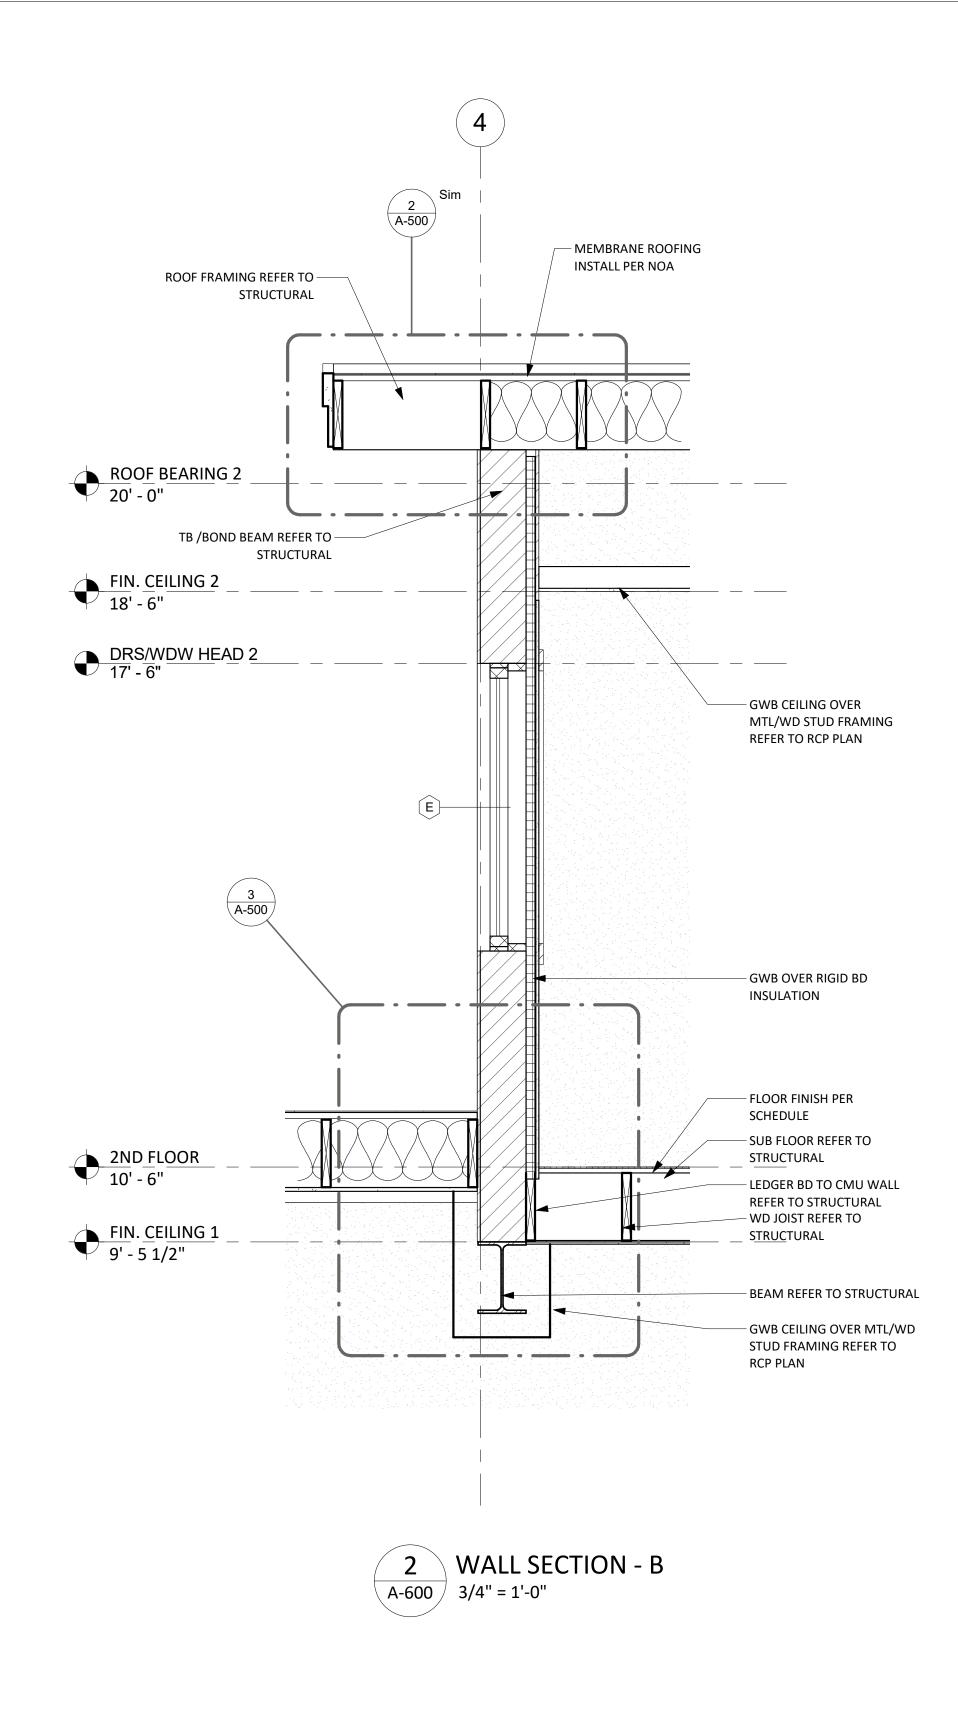PROTOTYPE SINGLE FAMILY HOME 2 STORY DATE REVISION DRAWN BY: PROJECT SITE ADDRESS: Vacant Lot #673 West 1st Street CHECKED BY Riviera Beach, FL 33404 Checker DQS PN#: 1713 06.22.18
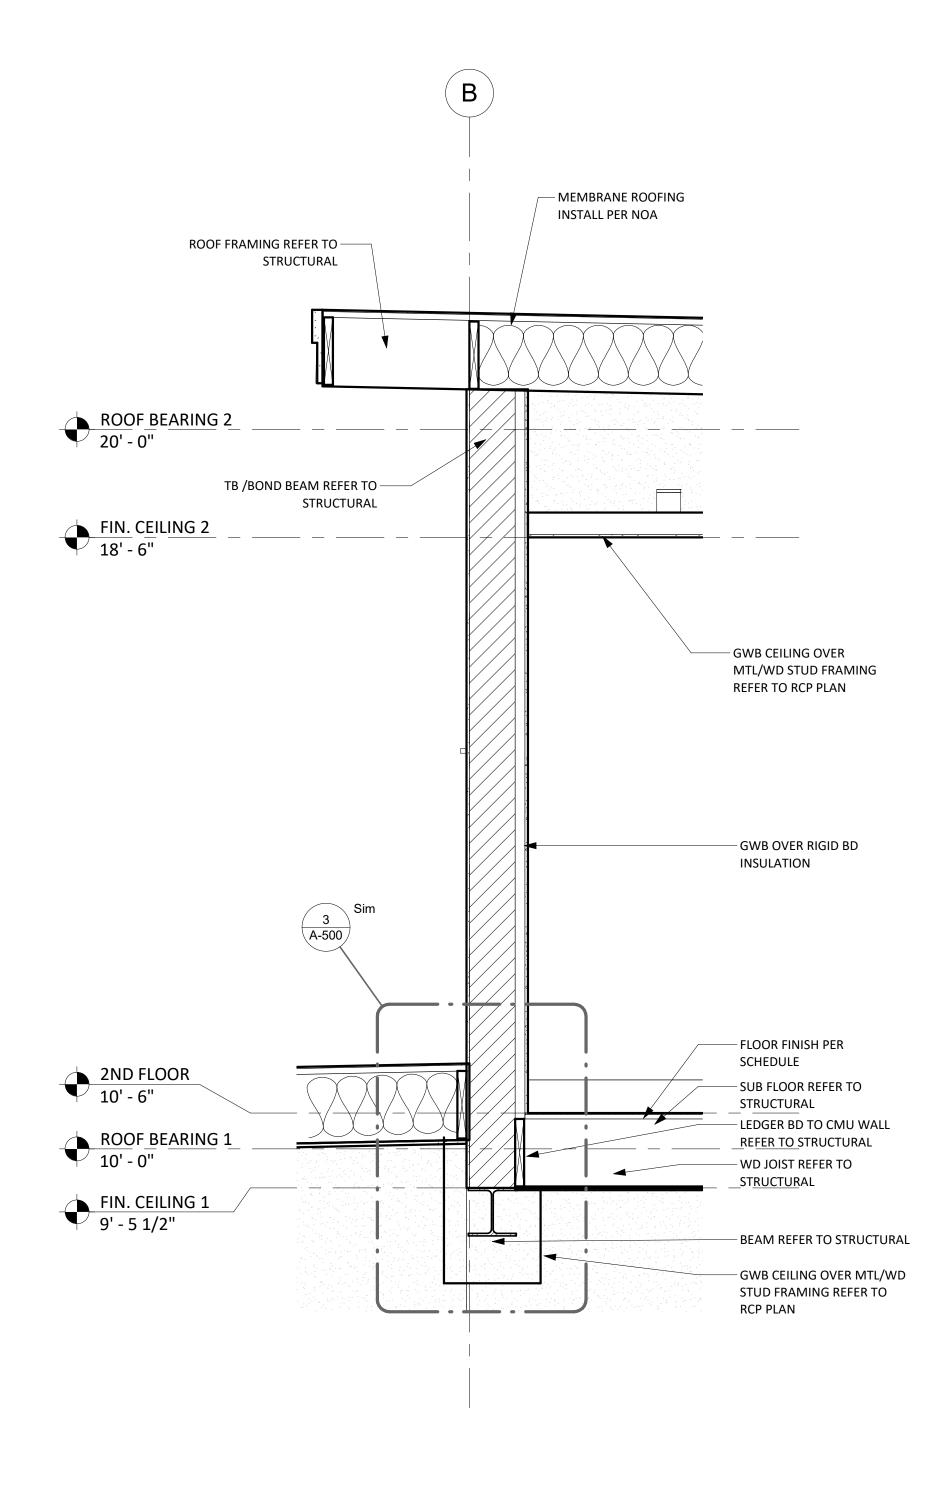
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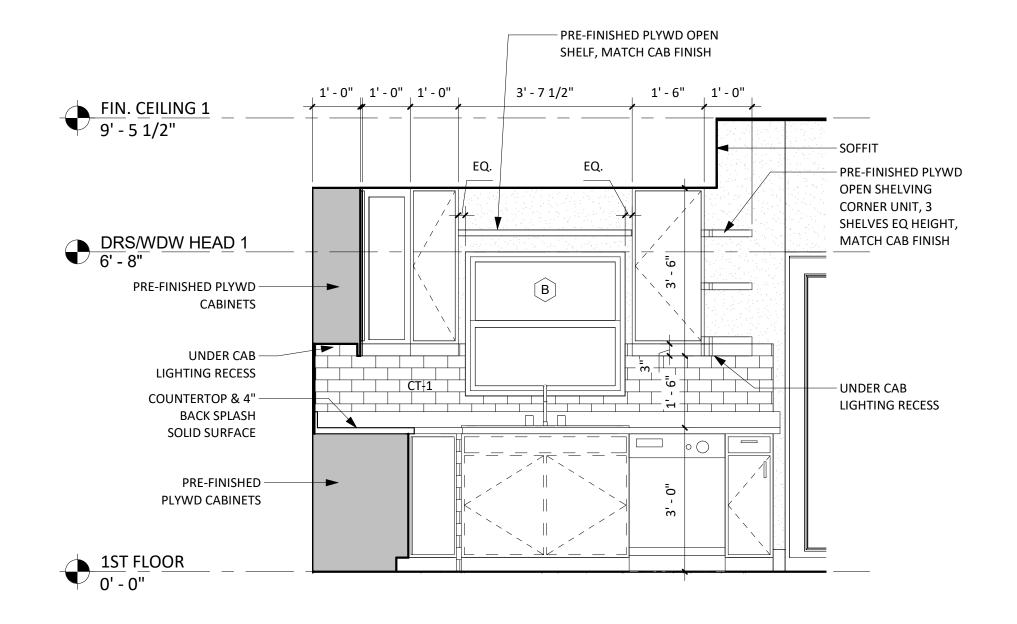
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2 KITCHEN - B

A-700 1/2" = 1'-0"



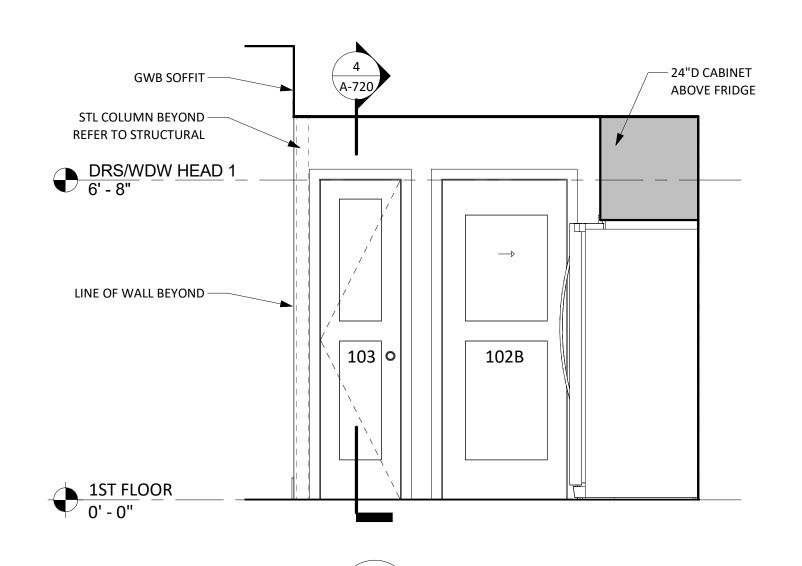

FINISH LEGEND

ITEM TAG	DESCRIPTION	MFR./BASIS OF DESIGN (BOD)	COMMENTS				
FLOORING:							
LVT	VINYL PLANK TILE 6"X48"	ARMSTRONG - VIVERO BETTER COLLECTION.	PROPER EXPANSION SPACE MUST BE MAINTAINED THROUGHOUT THE INSTALLATION. MATCH VIVERO - FLUSH STAIR NOSING PROFILE AT STAIRS.				
PT-1	PORCELAIN TILE, 6"X36"	DALTILE - SADDLE BROOK	ALL FIRST FLOOR, INCLUDING HALF BATH. PATTERN TO BE STAGGERED BRICK JOINT.				
WALL BASE:							
WD	WOOD BASE	1/2 IN. X 5-1/2 IN. PRIMED FINGER-JOINTED PINE BASE MOULDING, CRAFTSMAN PROFILE					
PVC	PVC COMPOSITE BASE	ROYAL BUILDING PRODUCTS 5523	GARAGE				
WALL TILE:							
PT-2	PORCELAIN TILE	DALTILE - SANMICHELE 18X18	BATH FLOORS. BATH WALLS TO 54" AFI UNO, TUB & SHOWER WALLS.				
PT-3	PORCELAIN TILE	DALTILE - SANMICHELE 2X4 MOSAIC	SHOWER FLOORS				
CT-1	CERAMIC WALL TILE	DALTILE - RITTENHOUSESQUARE 3X6	KITCHEN BACKSPLASH				
PAINT:							
PNT-1	INTERIOR, EGGSHELL		WALL COLOR				
PNT-2	INTERIOR, EGGSHELL	SHERWIN WILLIAMS, EMERALD INTERIOR ACRYLIC LATEX PAINT, COLORS TBD	ACCENT WALL COLOR				
PNT-3	INTERIOR, SEMI-GLOSS		TRIM				
PNT-4	INTERIOR, SATIN		INTERIOR DOORS				
PNT-5	INTERIOR, FLAT		CEILINGS				
PNT-6	INTERIOR GARAGE FLOOR COATING	SHERWIN WILLIAMS, H&C SHIELD-CRETE WATER-BASED EPOXY, COLOR TBD	GARAGE FLOOR				
PNT-7	EXTERIOR, EGGSHELL	SHERWIN WILLIAMS, EMERALD EXTERIOR ACRYLIC LATEX PAINT, COLOR TBD	EXTERIOR WALL COLOR				
PNT-8	EXTERIOR, EGGSHELL	SHERWIN WILLIAMS, EMERALD EXTERIOR ACRYLIC LATEX PAINT, COLOR TBD	EXTERIOR ACCENT WALL COLOR				
PNT-9	EXTERIOR, SEMI-GLOSS	SHERWIN WILLIAMS, SNAPDRY DOOR & TRIM PAINT, COLOR TBD	EXTERIOR DOOR & TRIM				
PNT-10	EXTERIOR, EGGSHELL	SHERWIN WILLIAMS, EMERALD EXTERIOR ACRYLIC LATEX PAINT, COLOR TBD	EXTERIOR ACCENT WALL COLOR				

NOTE: ALL FINISHES PER SPECIFICATION OR APPROVED EQUAL, GC TO SUBMIT ALL PROPOSED SUBSTITUTIONS TO THE ARCHITECT FOR REVIEW.

1. ALL PAINT TO BE 1 COAT PRIMER AND 2 COATS FINISH PAINT, UNO. 2. STUCCO PH (8-10) TESTING TO BE PREFORMED PRIOR TO ANY PAINTING


- 1. FOR TYPICAL INTERIOR WALLS, SOFFITS AND CEILINGS BOD: MIN. 1/2" USG SHEETROCK BRAND GYPSUM PANELS, OR EQUAL.
- 2. CEILING ABOVE GARAGE BOD: 5/8" USG SHEETROCK TYPE FIRECODE X, OR EQUAL.
- 3. WATER RESISTANT GWB BOD: USG SHEETROCK BRAND ULTRALIGHT PANELS MOLD TOUGH, OR EQUAL.
- 4. WALL TILE BACKER BOARD BOD: USG DUROCK BRAND GLASS-MAT TILE BACKERBOARD OR USG DUROCK BRAND CEMENT
- 5. NOTE ALL WALL SURFACES TO BE FINISHED TO LEVEL 4.

TILE NOTES:

- 1. SHOWER/TUB WALL TILE WATERPROOFING SYSTEM BOD: THE SCHLUTER- KERDI-SHOWER-KIT AND THE KERDI-TUBKIT, OR
- 2. AT WALL TILE TO GWB TERMINATION PROVIDE TERMINATION BAR PROFILE SCHLUTER JOLLY, FINISH TO MATCH ROOM FIXTURES, OR APPROVED EQUAL.

STUCCO NOTES:

- 1. ALL EXTERIOR STUCCO TO BE INSTALLED PER ASTM C926, 3 COAT SYSTEM, FINISH TEXTURE TO BE FINE SAND, LIGHT FLOAT
- TEXTURE FINISH. PNT COLOR PER FINISH SCHEDULE.
- 2. AFTER APPLYING FINISH COAT, MOIST CURE A MINIMUM OF 3 TIMES A DAY FOR A MINIMUM OF 3 5 DAYS AS DICTATED BY WEATHER OR AS NECESSARY TO REACH THE REQUIRED PH LEVEL TO RECEIVE PAINT. MAINTAIN FINISHED WORK IN A CONTINUOUSLY MOIST CONDITION BY PH TESTING UNTIL TEST READING IS 8-10. MAINTAIN A WRITTEN AND PHOTOGRAPHIC RECORD OF EACH SUCH TEST.

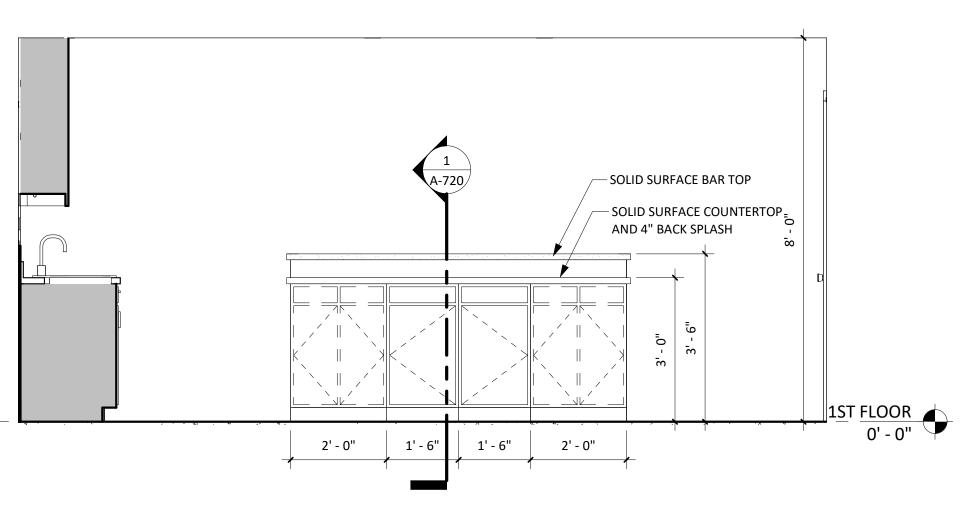

KITCHEN ISLAND A-700 / 1/2" = 1'-0"

FINISH SCHEDULE

ROOM NAME	ROOM #	Area	FLOOR	WALL BASE	WALL	CEILING	COMMENTS
GARAGE	101	242 SF	EPOXY	PVC	PNT	PNT	SLOPE FLOOR TO DRAIN TO OVERHEAD DOOR
UTILITY RM	102	44 SF	PT-1	WD	PNT	PNT	
PANTRY	103	2 SF	PT-1	WD	PNT	PNT	ADJ. WIRE SHELVING REFER TO DETAIL 04/A-720
KITCHEN	104	204 SF	PT-1	WD	PNT/CT-1	PNT	
LIVING RM	105	144 SF	PT-1	WD	PNT	PNT	
DINING RM	106	100 SF	PT-1	WD	PNT	PNT	
1/2 BATH	107	35 SF	PT-1	WD	PNT	PNT	
CLOSET	108	68 SF	PT-1	WD	PNT	PNT	CEILING SLOPES TO UNDERSIDE OF STAIRS ABOVE
FOYER	109	49 SF	PT-1	WD	PNT	PNT	
BEDROOM	200	97 SF	LVT	WD	PNT	PNT	
CLOSET	201 12 SF LVT		LVT	WD	PNT	PNT	CLOSET MAID ORGANIZER #287300
BEDROOM	202	99 SF	F LVT WD PNT		PNT		
LAV/SHOWER	203	39 SF	PT-2/PT-3	PT-2	PNT/PT-2	PNT	PT-3 FOR SHOWER FLOORS
BATH	204	32 SF	PT-2	PT-2	PNT/PT-2	PNT	
M/BEDROOM	205	164 SF	LVT	WD	PNT	PNT	
BATH	206	39 SF	PT-2	PT-2	PNT/PT-2	PNT	
STUDY	207	28 SF	LVT	WD	PNT	PNT	
HALLWAY	208	62 SF	LVT	WD	PNT	PNT	
CLOSET	209	12 SF	LVT	WD	PNT	PNT	CLOSET MAID ORGANIZER #287300
CLOSET	210	4 SF	LVT	WD	PNT	PNT	ADJ. WIRE SHELVING REFER TO DETAIL 04/A-720
CLOSET	211	28 SF	LVT	WD	PNT	PNT	CLOSET MAID ORGANIZER #7880900 AND 3X 12"X48"
							SHELVING #563100

APPLIANCES BOD

ITEM	MFR.	MODEL#	COLOR/FINISH	COMMENTS	
RANGE	LG	LRE3083	SS		
FRIDGE	LG	LSXC22426S	SS		
DISHWASHER	LG	LDF5545	SS		
MICROWAVE	LG	LSRM2085ST	SS		
HOOD	LG	LSHD3689BD	SS		
WASHING M.	LG	WT7200CW	WHITE		
DRYER	LG	DLE7200WE	WHITE		

PLUMBING FIXTURES BOD:

- · SINK: JUST, #ODL 2233 A GR L. STRAINER #JDP-35
- · FAUCET: MOEN, # 7594SRS, ARBOR ONE-HANDLE HIGH ARC PULLDOWN KITCHEN FAUCET FEATURING REFLEX, SPOT RESIST
- GARBAGE DISPOSAL: MOEN, #GXS75C, GX SERIES 3/4 HORSEPOWER.

· ICE MAKER BOX: GUY GRAY #AB9700HACP.

- **BATHROOMS:** BATHROOM SINK: KOHLER, #K-2699-4-0, BRYANT
- FAUCET: MOEN, #84603, ADLER CHROME.
- TUB: AMERICAN STANDARD, 0255 ENAMELED STEEL, INTEGRAL APRON. TUB FAUCET: MOEN, #82603, ADLER, W/SPRAY HEAD HAND SHOWER #20006.
- SHOWER FAUCET: MOEN, #82604, ADLER, W/SPRAY HEAD HAND SHOWER #20006.
- WATER CLOSET: FLOOR MOUNTED 2 PIECE TANK TYPE, KOHLER #K-3999-0 HIGHLINE COMFORT HEIGHT

LAUNDRY:

· WASHING MASHING BOX: GUY GRAY #MWB26

OR APPROVED EQUALS.

BATHROOM ACCESSORIES BOD:

BOD: MOEN, FINISH CHROME, OR APPROVED EQUALS.

TOWEL BAR 18": BP6918CH

TOWEL BAR 24": BP6924CH TOWEL SHELF W/RACK 24": DN0794CH

SHOWER ROD CURVED: CSR2160CH

TOWEL RING: BP6986CH TOILET PAPER HOLDER: BP6908CH

ROBE HOOK: YB0403CH

KITCHEN CABINETRY BOD:

BOD: KRAFTMAID, OR APPROVED EQUAL:

- 1. CABINET CONSTRUCTION TO BE ALL PRE-FINISHED PLYWOOD (APC).
- 2. DRAWER CONSTRUCTION 3/4" SOLID WOOD FULL-DEPTH DRAWER WITH FOUR-SIDED DOVETAIL CONSTRUCTION AND 3/16"
- PLYWOOD BOTTOM.
- 2. CABINET INTERIOR FINISH TO BE NATURAL BIRCH.
- 3. CABINET DOORS BOD: PUTMAN, DELUXE RECESSED PANEL DRAWER(DRPD) COLOR TBD.
- 4. DOOR HARDWARE: BAR PULL COLLECTION 5. HINGES: SOFT CLOSE WHISPER TOUCH.

DRAWN BY: PROJECT SITE ADDRESS:

CHECKED BY

Checker

DQS PN#:


1713

KITCHEN COUNTERTOP BOD:

Vacant Lot #673 West 1st Street

1. SOLID SURFACE BOD: WILSONART, 1/2" THICKNESS, COLOR SELECTION FROM PRICE GROUP #2. WITH 4" BACKSPLASH. OR APPROVED EQUAL.

PROTOTYPE SINGLE FAMILY HOME 2 STORY

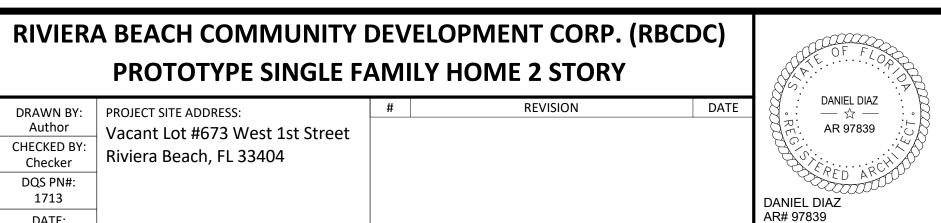



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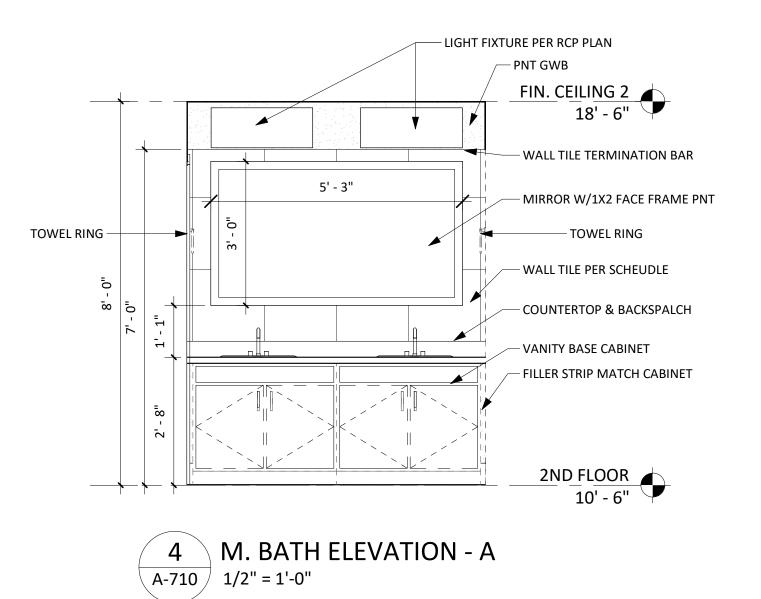
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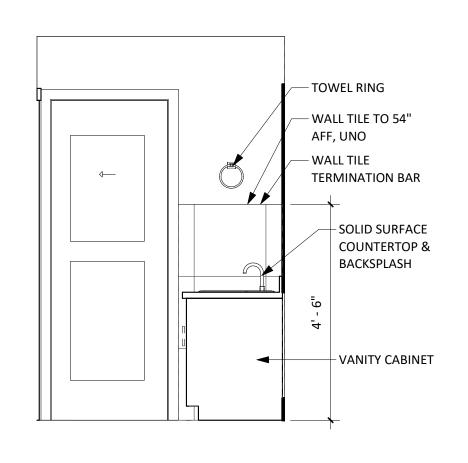
FINISH SCHEDULE & DETAILS

REVISION







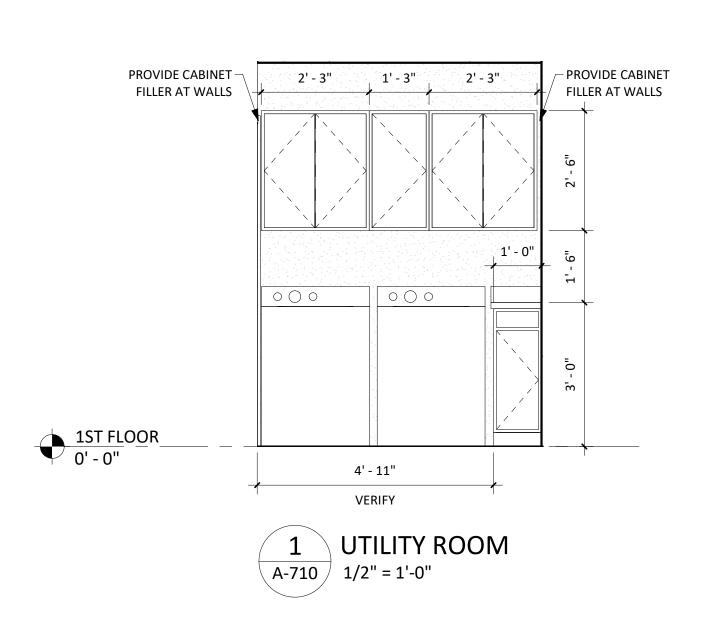


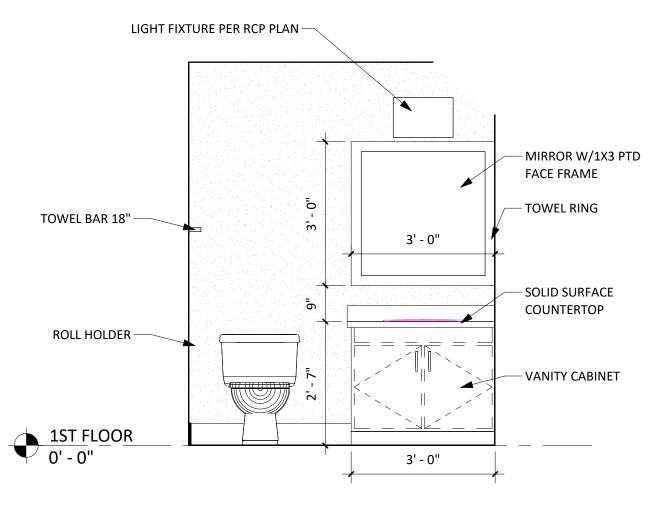


M. BATH VANITY TYP. SIDE WALL A-710 1/2" = 1'-0"

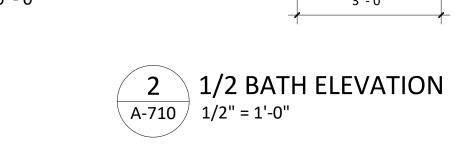


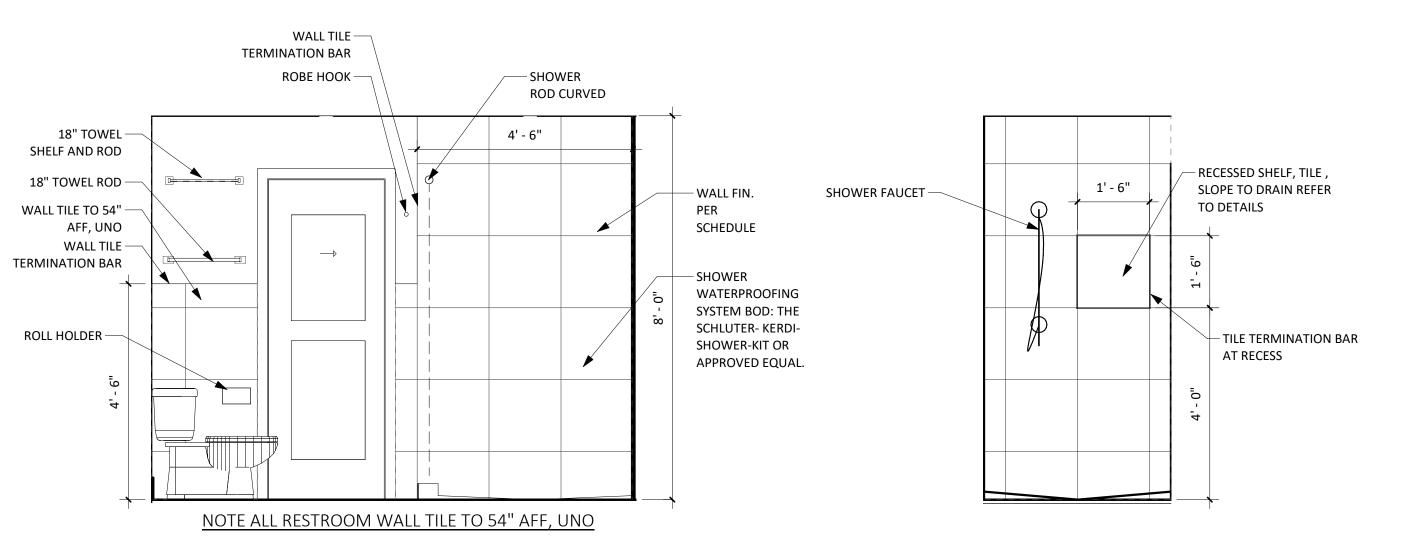


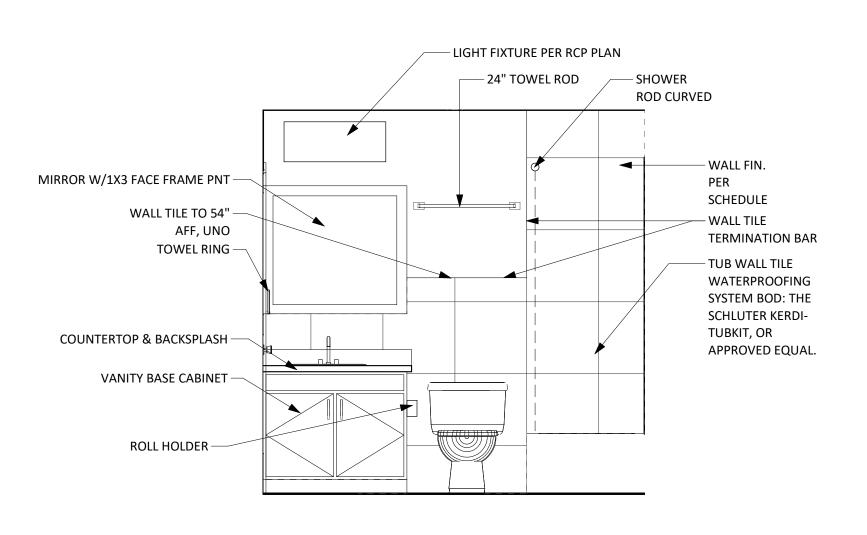

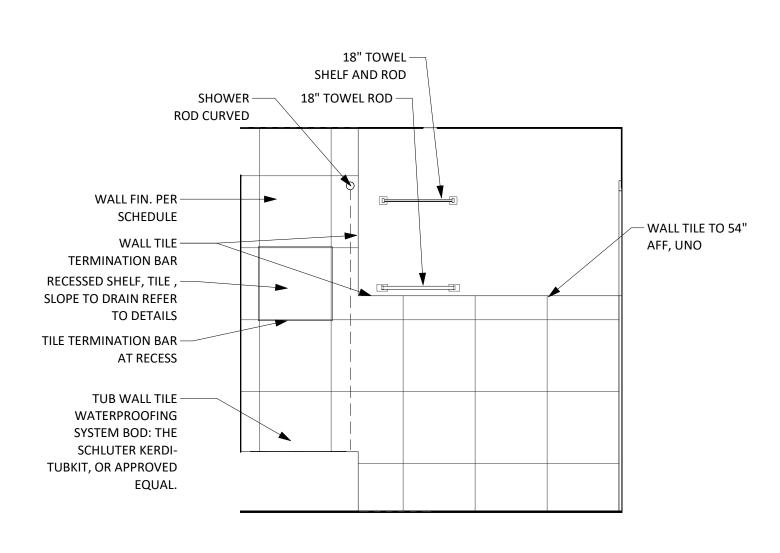



6 M.BATH LAVATORY ELEVATION - A A-710 / 1/2" = 1'-0"

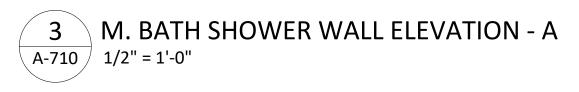

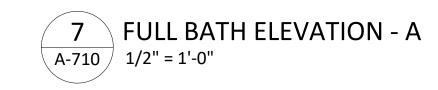

8 FULL BATH ELEVATION - B A-710 1/2" = 1'-0"

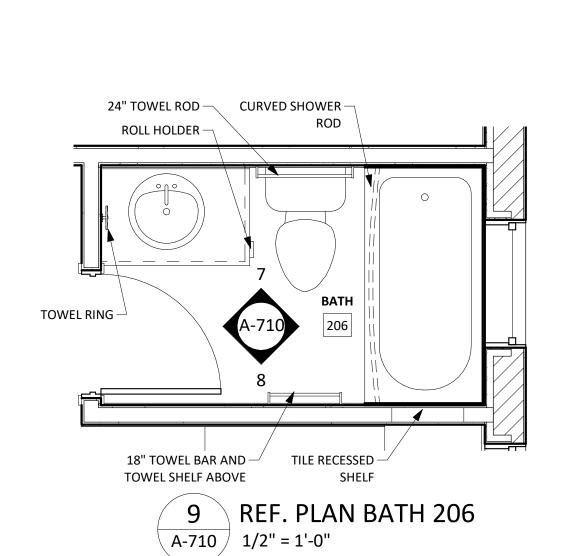

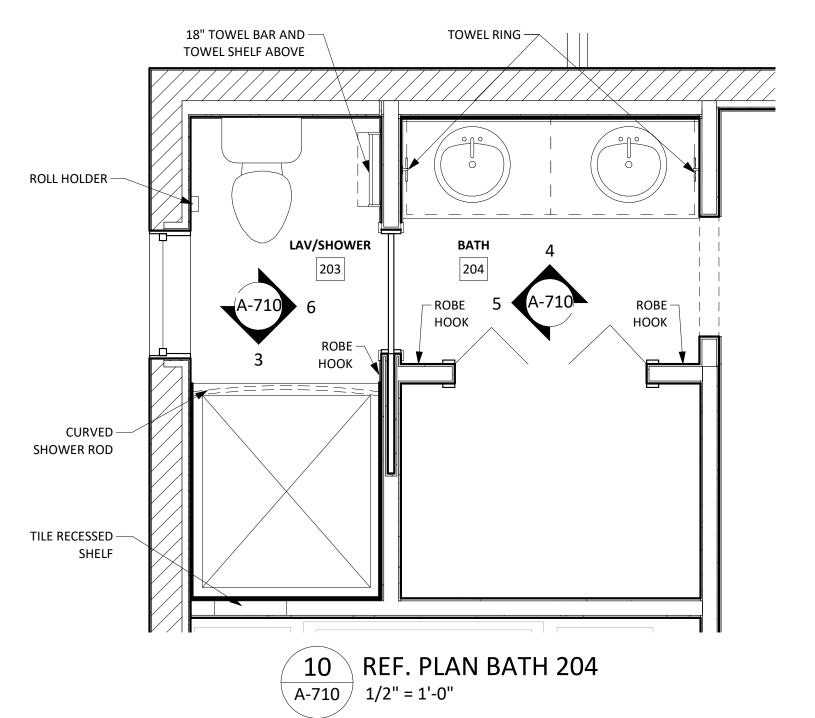

BATHROOM ACCESSORIES BOD:

BOD: MOEN, FINISH CHROME, OR APPROVED EQUALS.


TOWEL BAR 18": BP6918CH TOWEL BAR 24": BP6924CH TOWEL SHELF W/RACK 24": DN0794CH SHOWER ROD CURVED: CSR2160CH TOWEL RING: BP6986CH TOILET PAPER HOLDER: BP6908CH ROBE HOOK: YB0403CH


BATH & UTILITY ROOMS CABINETRY BOD:


1. BOD KRAFTMAID SUMMERFIELD COLLECTION, SQUARE RECESSED PANEL VENEER DOORS, DOVE WHITE OR APPROVED


2. CABINET CONSTRUCTION TO BE ALL PRE-FINISHED PLYWOOD (APC). 3. CABINET INTERIOR FINISH TO BE NATURAL BIRCH.


TENSIONS TO THIS PROJECT EXCEPT BY WRITTEN AUTHORIZATION OF D&Q STUDIO C. ANY SUCH UNAUTHORIZED USE WILL BE SOLELY AT THE USER'S RISK AND D&Q UDIO LLC WILL BEAR NO RESPONSIBILITY ARISING OUT OF SUCH USE.

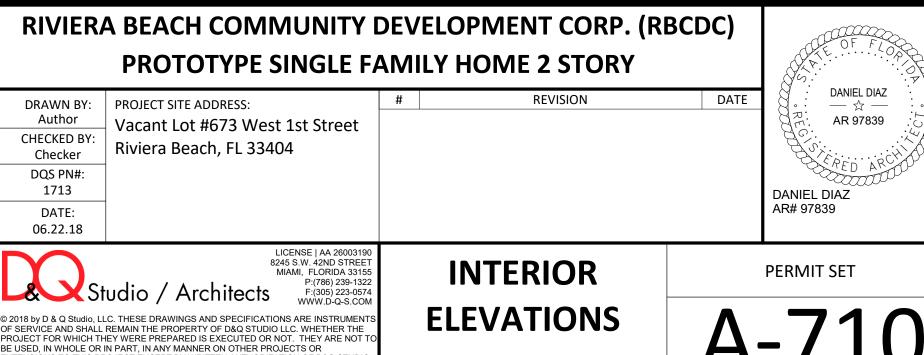


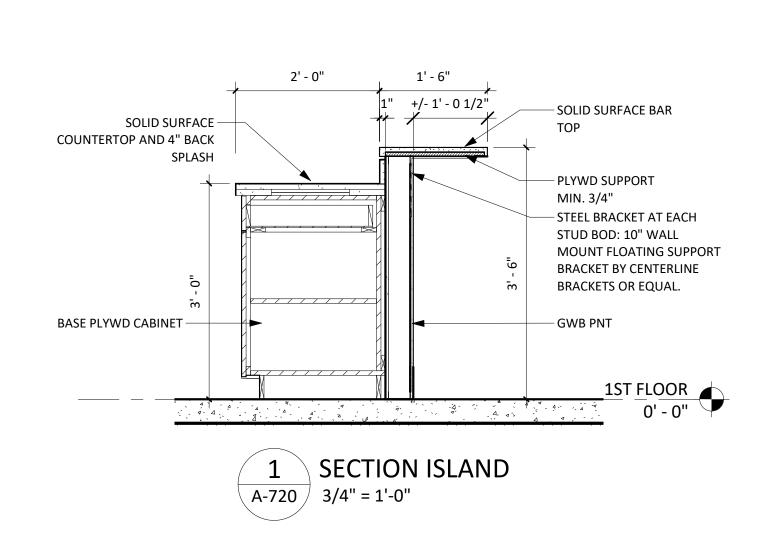


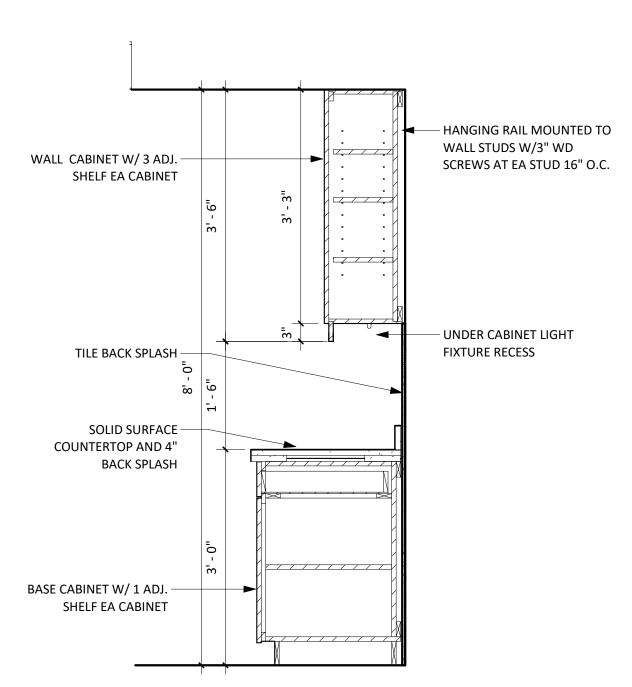

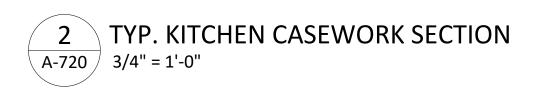

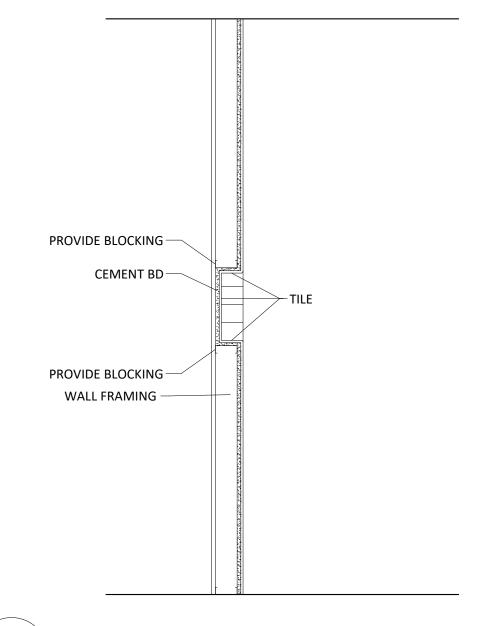

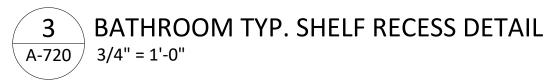


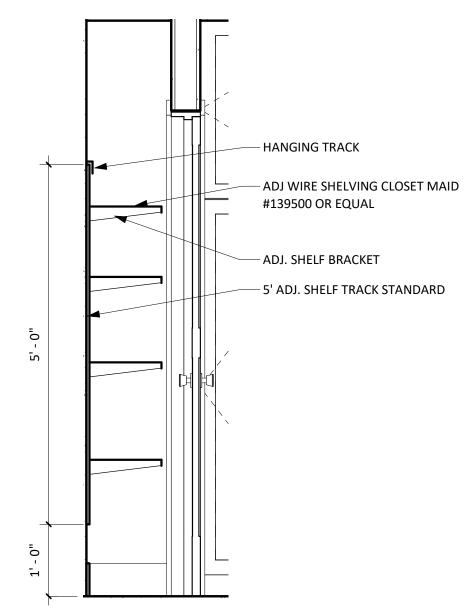



4 ADJ. WIRE SHELVING DETAIL 3/4" = 1'-0"




RIVIER	A BEACH COMMUNITY I		•	BCDC)	OF FLOR
DRAWN BY: JQ CHECKED BY: Checker DQS PN#: 1713 DATE: 06.22.18	PROJECT SITE ADDRESS: Vacant Lot #673 West 1st Street Riviera Beach, FL 33404	#	REVISION	DATE	DANIEL DIAZ AR 97839 DANIEL DIAZ AR 97839 AR 97839
© 2018 by D & Q Studio, LI OF SERVICE AND SHALL PROJECT FOR WHICH TH BE USED, IN WHOLE OR EXTENSIONS TO THIS PF LLC. ANY SUCH UNAUTH	LICENSE AA 26003190 8245 S.W. 42ND STREET MIAMI, FLORIDA 33155 P:(786) 239-1322 F:(305) 223-0574 WWW.D-Q-S.COM C. THESE DRAWINGS AND SPECIFICATIONS ARE INSTRUMENTS REMAIN THE PROPERTY OF D&Q STUDIO LLC. WHETHER THE 1EY WERE PREPARED IS EXECUTED OR NOT. THEY ARE NOT TO 1N PART, IN ANY MANNER ON OTHER PROJECTS OR 1OJECT EXCEPT BY WRITTEN AUTHORIZATION OF D&Q STUDIO 1ORIZED USE WILL BE SOLELY AT THE USER'S RISK AND D&Q 1NO RESPONSIBILITY ARISING OUT OF SUCH USE.		INTERIOR DETAILS	A	PERMIT SET -720

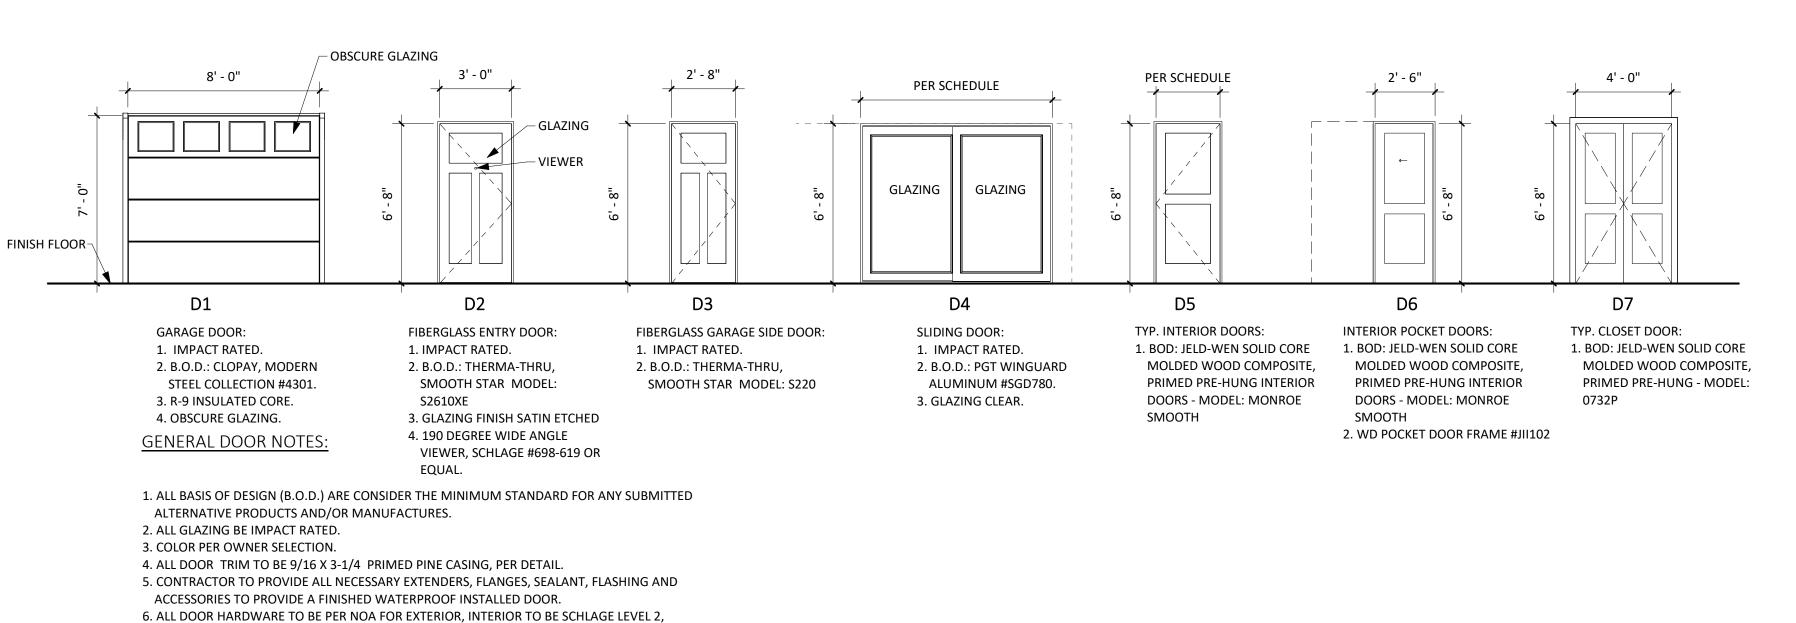

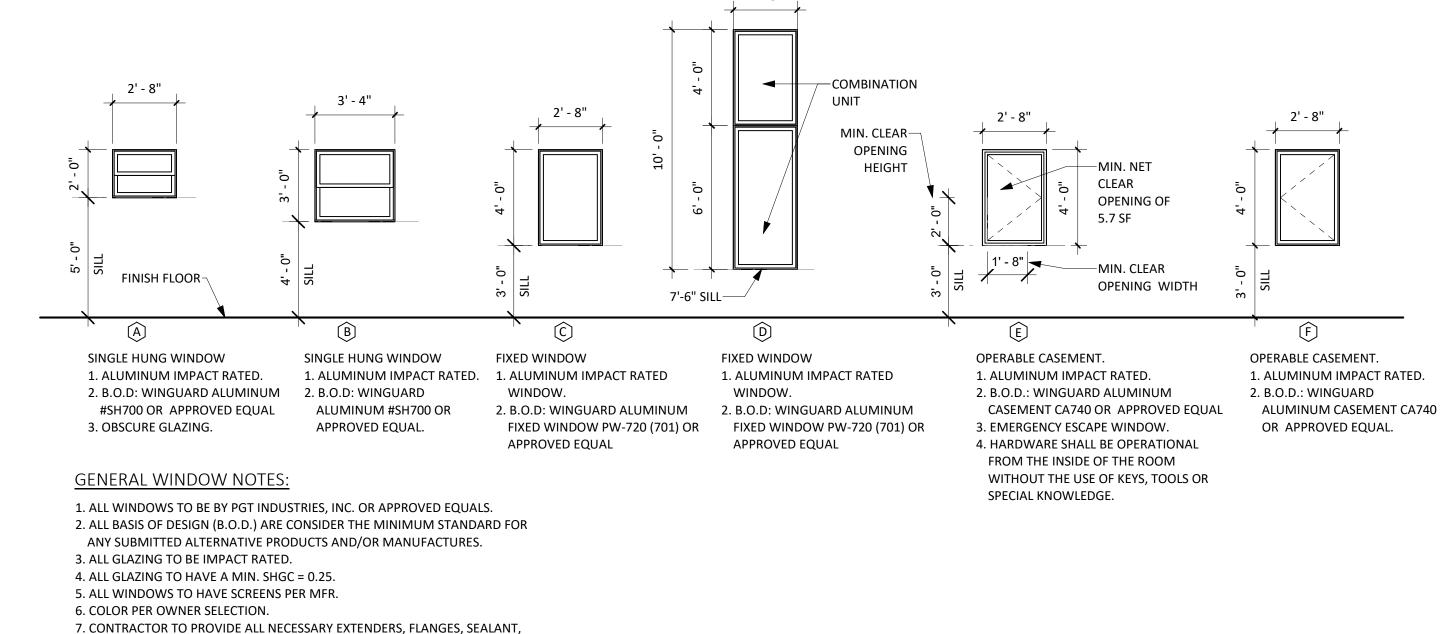


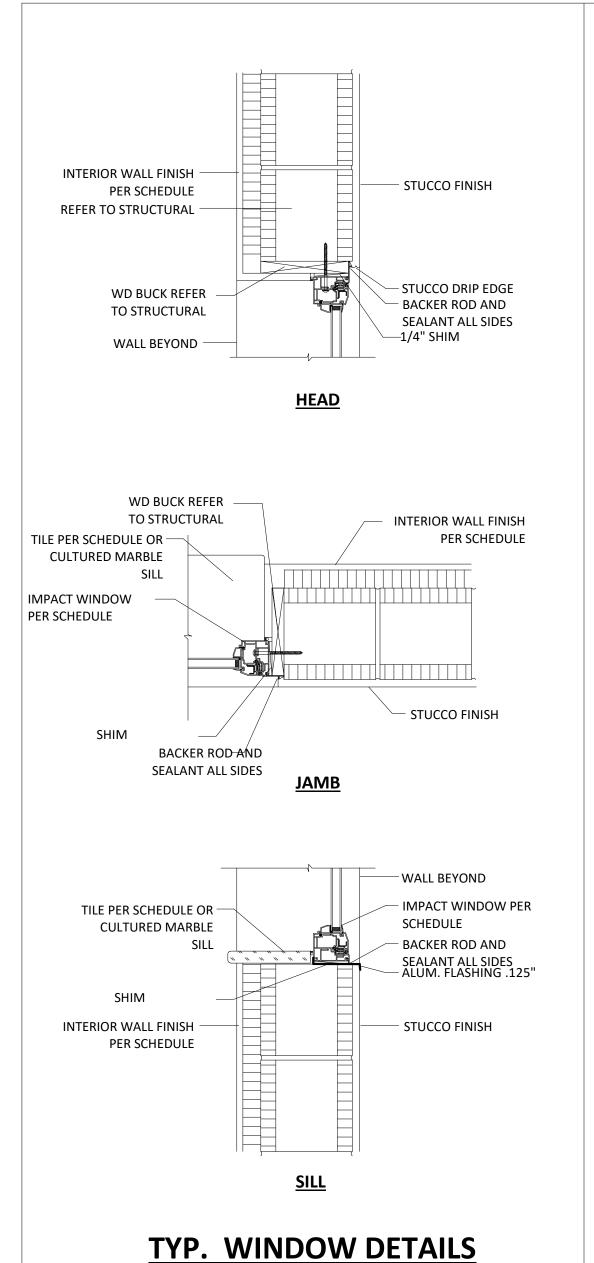


GRADE D OR APPROVED EQUAL.

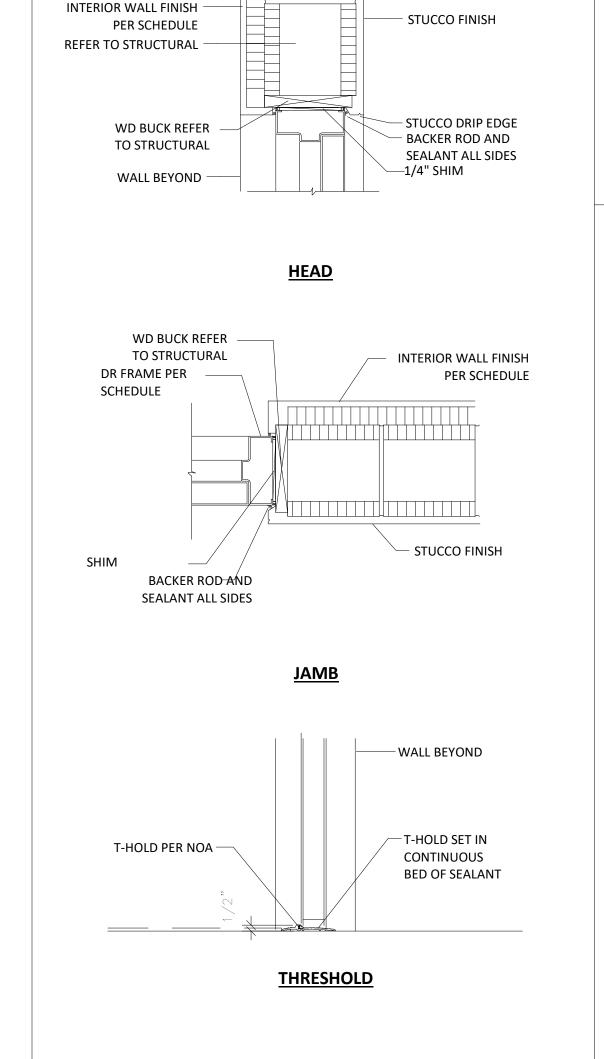

TYP. EXTERIOR DOOR DETAILS

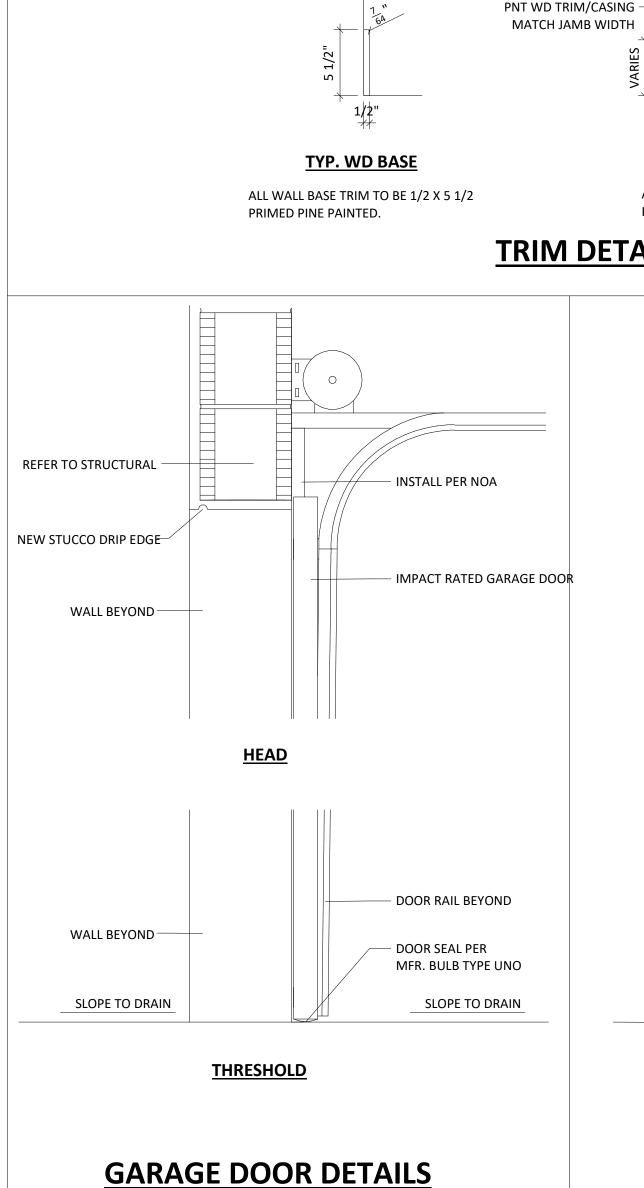

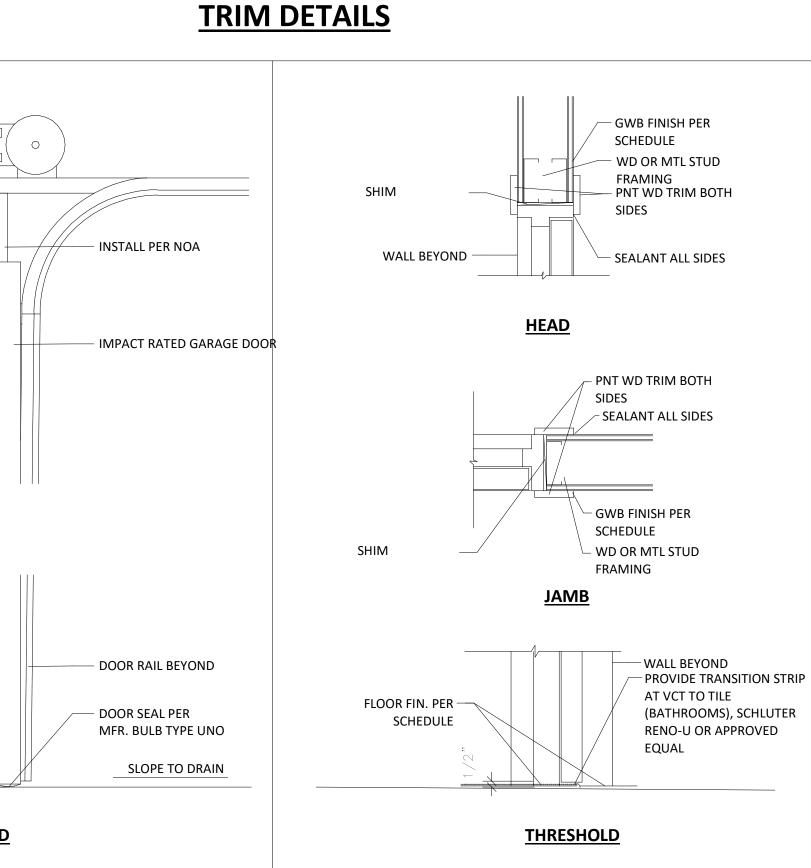

TYP. INTERIOR DOOR DETAILS

FLASHING AND ACCESSORIES TO PROVIDE A FINISHED WATERPROOF INSTALLED

WINDOW.

DOOR TRIM

─ PNT WD TRIM

TYP CASED OPENING

ALL DOOR TRIM TO BE 9/16 X 3-1/4

PRIMED PINE PAINTED.


- PNT WD TRIM MATCH

/ SEALANT ALL SIDES

BASE BOARD BELOW





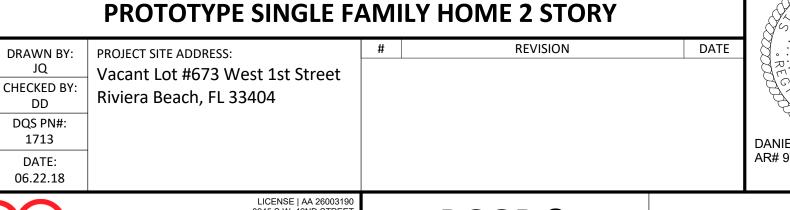


DATE:
06.22.18


LICENSE | AA 26003190
8245 S.W. 42ND STREET
MIAMI, FLORIDA 33155
P:(786) 239-1322
F:(305) 223-0574
WWW.D-Q-S.COM

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DANIEL DIAZ

AR 97839



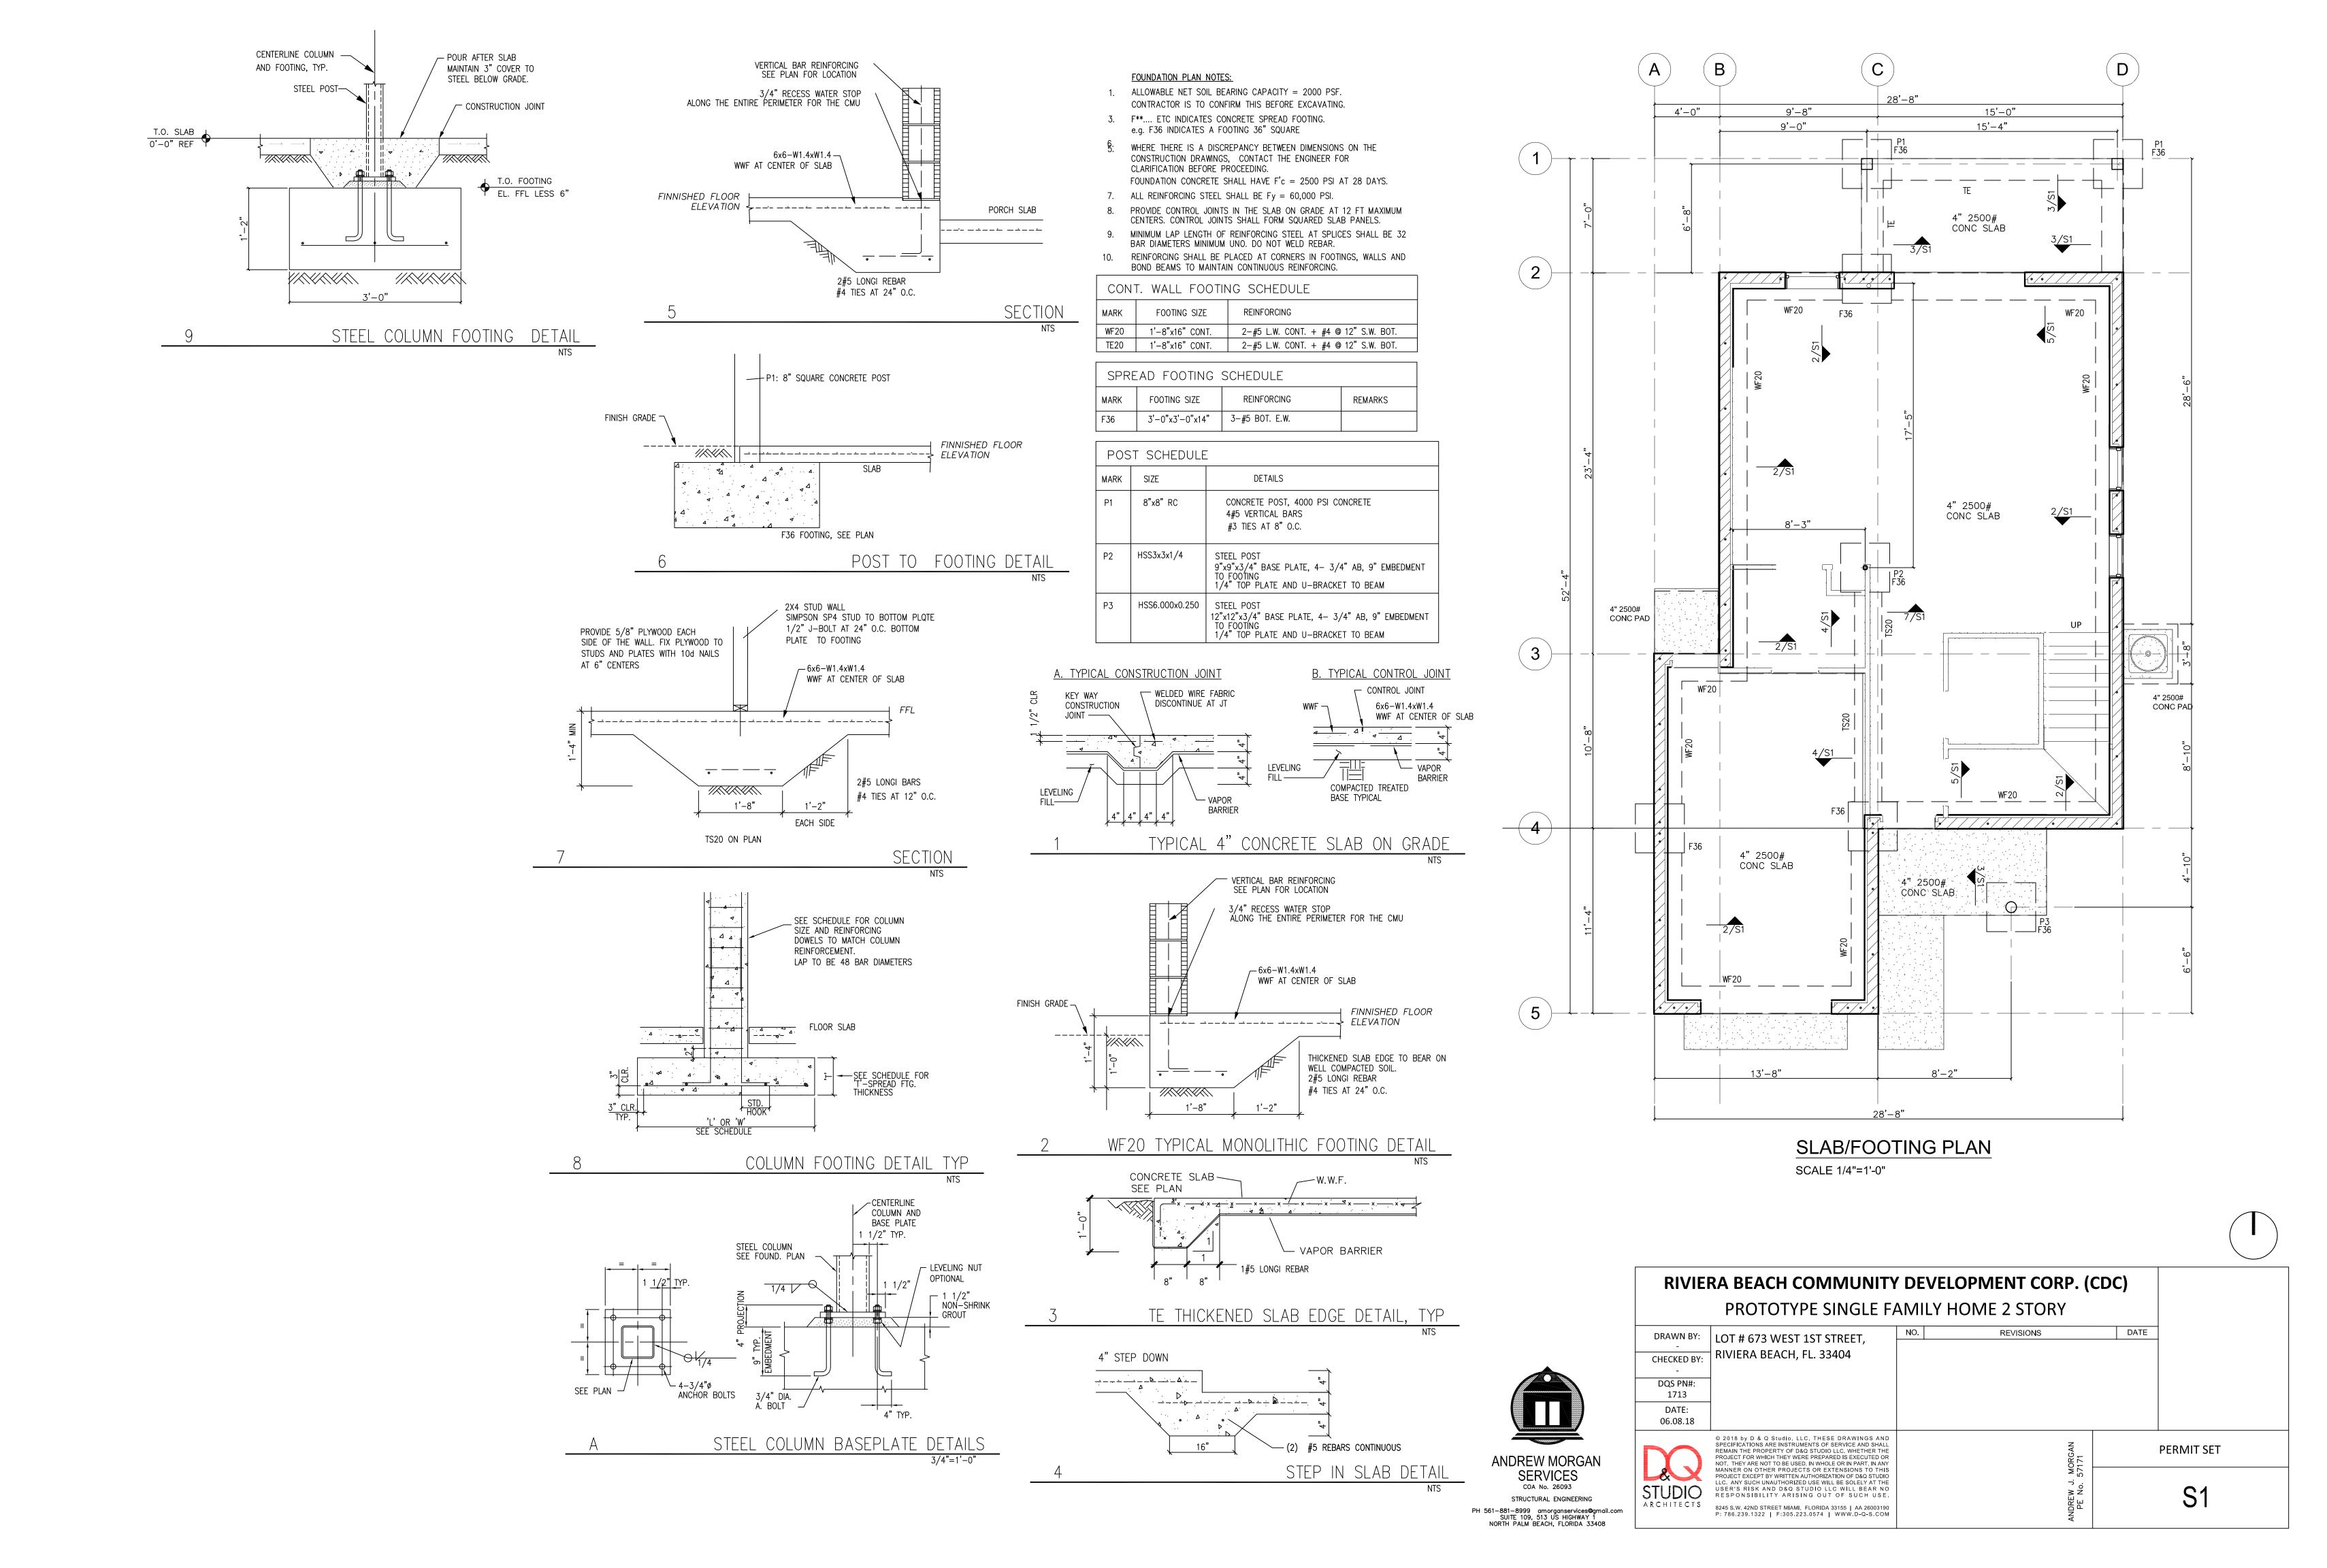

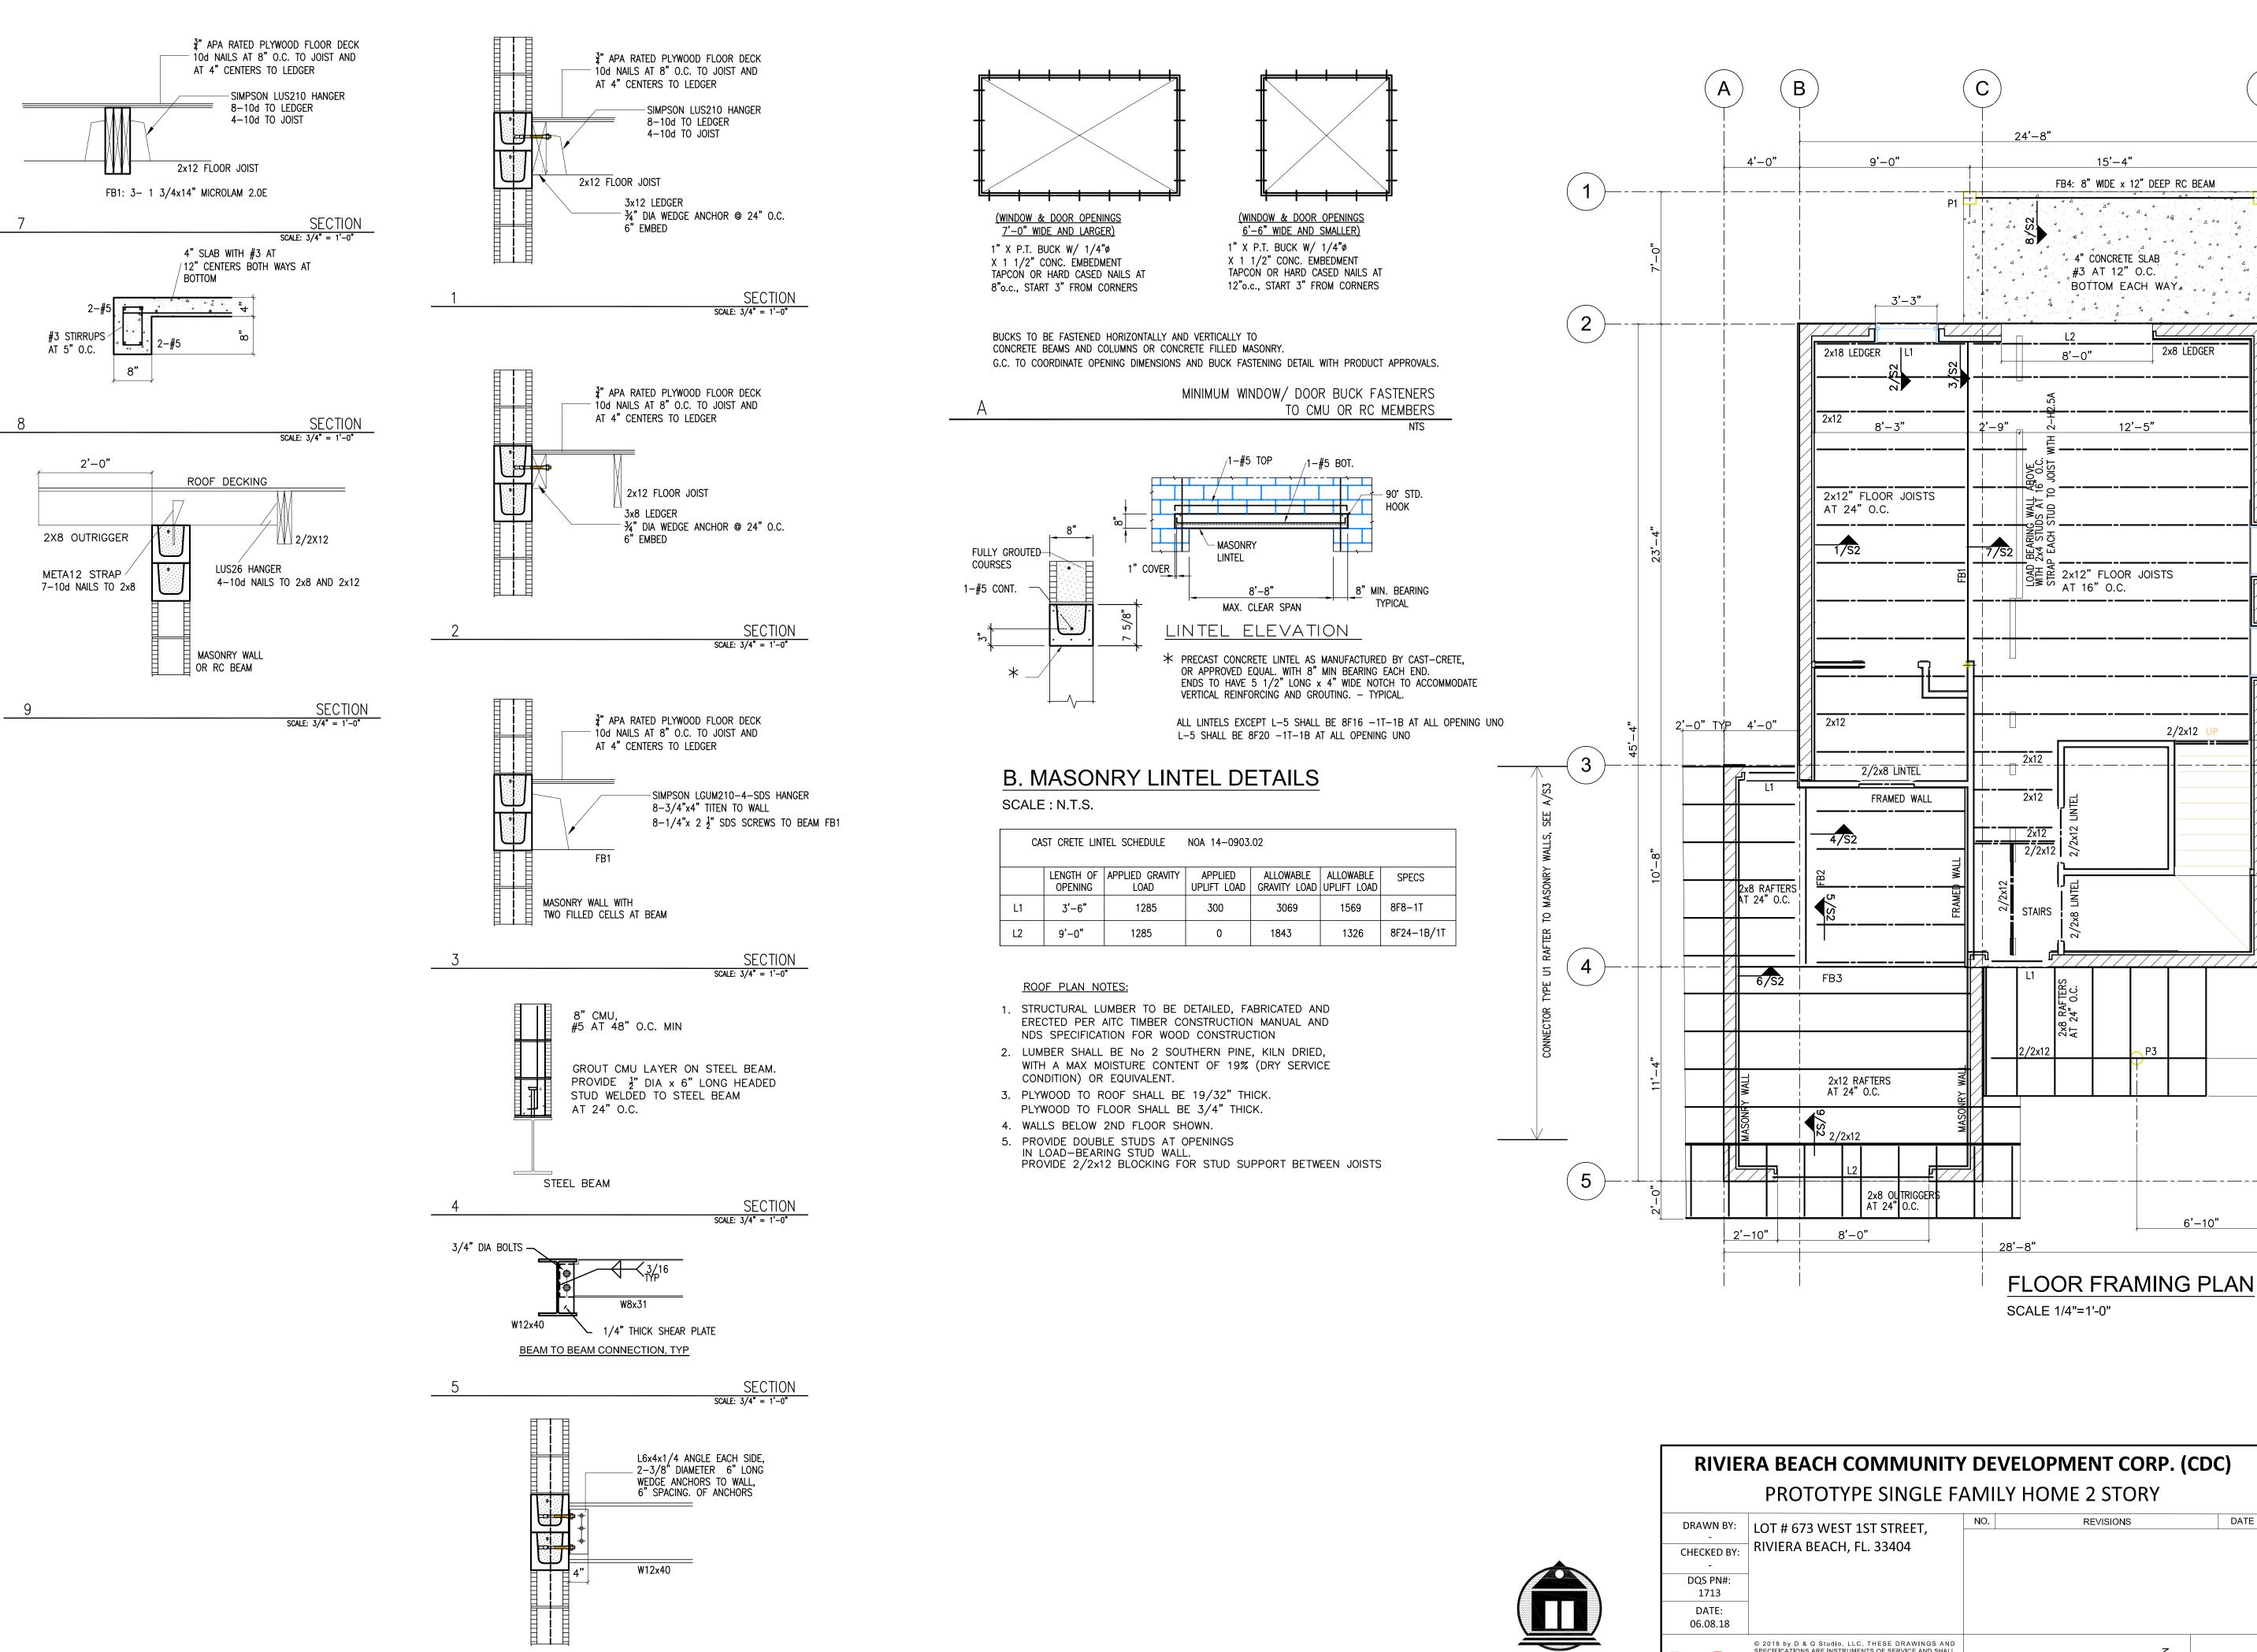SECTION

SCALE: 3/4" = 1'-0"



(D)

15'-4"

4" CONCRETE SLAB

#3 AT 12" O.C.

8'-0"


BOTTOM EACH WAY

12'-5"

2/2x12 ∪

6'-10"

FB4: 8" WIDE x 12" DEEP RC BEAM

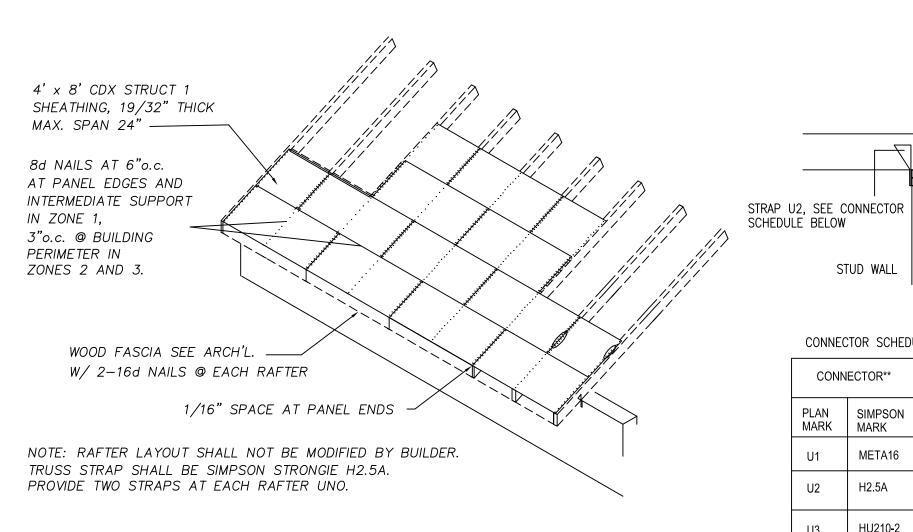

PLYWOOD NAILING DETAILS

DESIGN CRITERIA DESIGN LOADING PER FBC 2014, WIND LOADS PER ASCE 7 10

ROOF LIVE LOAD = 20 PSF ROOF DEAD LOAD = 20 PSF BASIC ULTIMATE WIND SPEED = 170 MPH (134 MPH ASD)

RISK CATEGORY II BUILDING: ENCLOSED WIND EXPOSURE = EXPOSURE B Kd = 0.85

INTERNAL PRESSURE COEFFICIENT = +/- 0.18 ULT WIND PRESSURE (Lateral Force Resisting System) = 36 PSF ULT WIND PRESSURE (Component and Cladding) = 44 PSF WIND ZONE a = 3'-0"IMPACT RESISTANCE ASSEMBLY: YES TYPE OF CONSTRUCTION: CBS

	5	4	5	
-	a	<u> </u>	а	· }

WALL WIND ZONES: COMPONENTS AND CLADDING DESIGN


ROOF SHEATHING NAILING PATTERN ZONE #1 = 8d AT 6" o.c. FIELD & 4" o.c. EDGE

ZONE #2 = 8d AT 6" o.c. EDGE & FIELD ZONE #3 = 8d AT 4" o.c. FIELD & EDGE USE 8d RING SHANK NAILS

MEAN ROOF HEIGHT = 21 FT

COMPONENT	AND CLAD	DING WIND PRESSUR	ES ROOF SLO	PE < 7 DEG.								
			TRIBUTARY AF	REA (SQ. FT.)								
AREA	ZONE		10	20								
MAIN ROOF	1,2&3	PRESSURE psf	30	29								
	1	SUCTION psf	-48	-47								
	2	SUCTION psf	-83	-80								
	3	SUCTION psf	-122	-119								
OVERHANG	2	SUCTION psf	-105	-105								
	3	SUCTION psf	-171	-165								
	4&5	PRESSURE psf	52	52								
WALL	4	SUCTION psf	-52	-51								
	5	SUCTION psf	-63	-63								

TABLE 1: ULTIMATE COMPONENT AND CLADDING PRESSURES

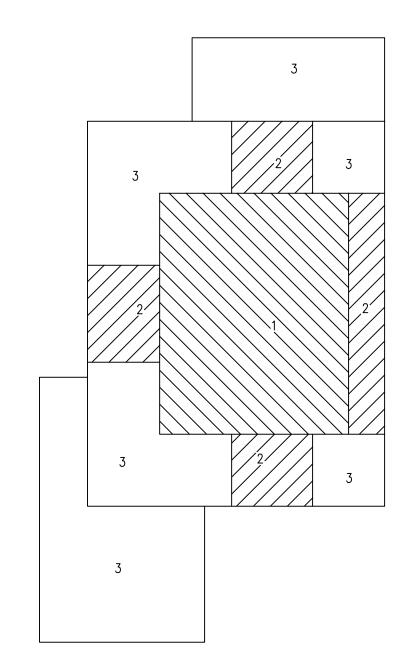

ROOF WIND ZONES: COMPONENTS AND CLADDING DESIGN

5. ROOF SLOPE 1/4" IN 12". SEE ARCHITECTURAL SECTIONS.

ROOF PLAN NOTES:

- STRUCTURAL LUMBER TO BE DETAILED, FABRICATED AND ERECTED PER AITC TIMBER CONSTRUCTION MANUAL AND NDS SPECIFICATION FOR WOOD CONSTRUCTION
- 2. LUMBER SHALL BE No 2 SOUTHERN PINE, KILN DRIED, WITH A MAX MOISTURE CONTENT OF 19% (DRY SERVICE CONDITION) OR EQUIVALENT.
- 3. PLYWOOD TO ROOF TO BE 19/32" THICK MIN.

4. WALLS BELOW ROOF SHOWN. L3: 2x10 LINTEL SEE ARCHITECTURAL DRAWINGS FOR OVERHANG 15'-5" __-_-2x12 RAFTERS AT 24" O.C.

F2 LBS CONNECTOR** ANCHORING DETAILS AT REACTION LBS TO R.C TIE BEAM/ STUD WALL MARK MARK META16 8 -10d x1 1/2 EMBED INTO R.C. BEAM H2.5A HU210-2 1135 14-1/4" x1 3/4" TITEN 2

** CONNECTORS ARE BY SIMPSON-STRONGTIE

STUD WALL

CONNECTOR SCHEDULE

ALL CONNECTORS ARE TO BE OF HOT-DIPPED GALVANIZED STEEL AND SHALL BE TYPE U1 UNO.. DO NOT CHANGE THE RAFTER LAYOUT.

RAFTER

2#5 LONGI BARS,

CONCRETE MASONRY

IN 180 DEGREE HOOK.


TO TOP OF WALL

AND TERMINATE

16" DEEP CMU BOND BEAM -

CMU WALL REBAR, CONTINUE

RAFTER & ROOF BEAM CONNECTOR DETAILS

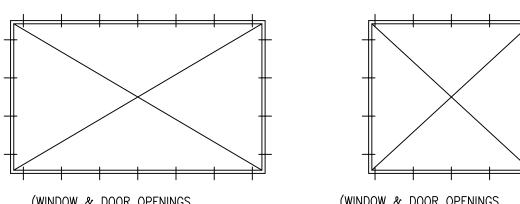

(WINDOW & DOOR OPENINGS <u>7'-0" WIDE AND LARGER)</u> 1" X P.T. BUCK W/ 1/4"ø X 1 1/2" CONC. EMBEDMENT TAPCON OR HARD CASED NAILS AT

8"o.c., START 3" FROM CORNERS

(WINDOW & DOOR OPENINGS 6'-6" WIDE AND SMALLER) 1" X P.T. BUCK W/ 1/4"ø X 1 1/2" CONC. EMBEDMENT TAPCON OR HARD CASED NAILS AT 12"o.c., START 3" FROM CORNERS

ELEV T.O. BEAM

DIMENSIONS; 2'-0" TYPICALLY.

STRAP SEE CONNECTOR


SCHEDULE BELOW

LATERAL FORCE F1 IS

PERPENDICULAR TO F2.


BUCKS TO BE FASTENED HORIZONTALLY AND VERTICALLY TO CONCRETE BEAMS AND COLUMNS OR CONCRETE FILLED MASONRY. G.C. TO COORDINATE OPENING DIMENSIONS AND BUCK FASTENING DETAIL WITH PRODUCT APPROVALS.


MINIMUM WINDOW/ DOOR BUCK FASTENERS TO CMU OR RC MEMBERS

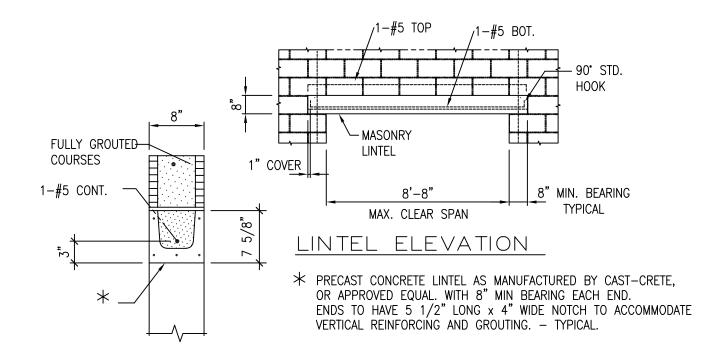


C. MASONRY LINTEL DETAILS SCALE: N.T.S.


CAST CRETE LINTEL SCHEDULE NOA 14-0903.02											
	LENGTH OF OPENING	APPLIED GRAVITY LOAD	APPLIED UPLIFT LOAD	ALLOWABLE GRAVITY LOAD	ALLOWABLE UPLIFT LOAD	SPECS					
L1	3'-6"	1285	300	3069	1569	8F8-1T					
L2	9'-0"	1285	0	1843	1326	8F16-1B/1T					

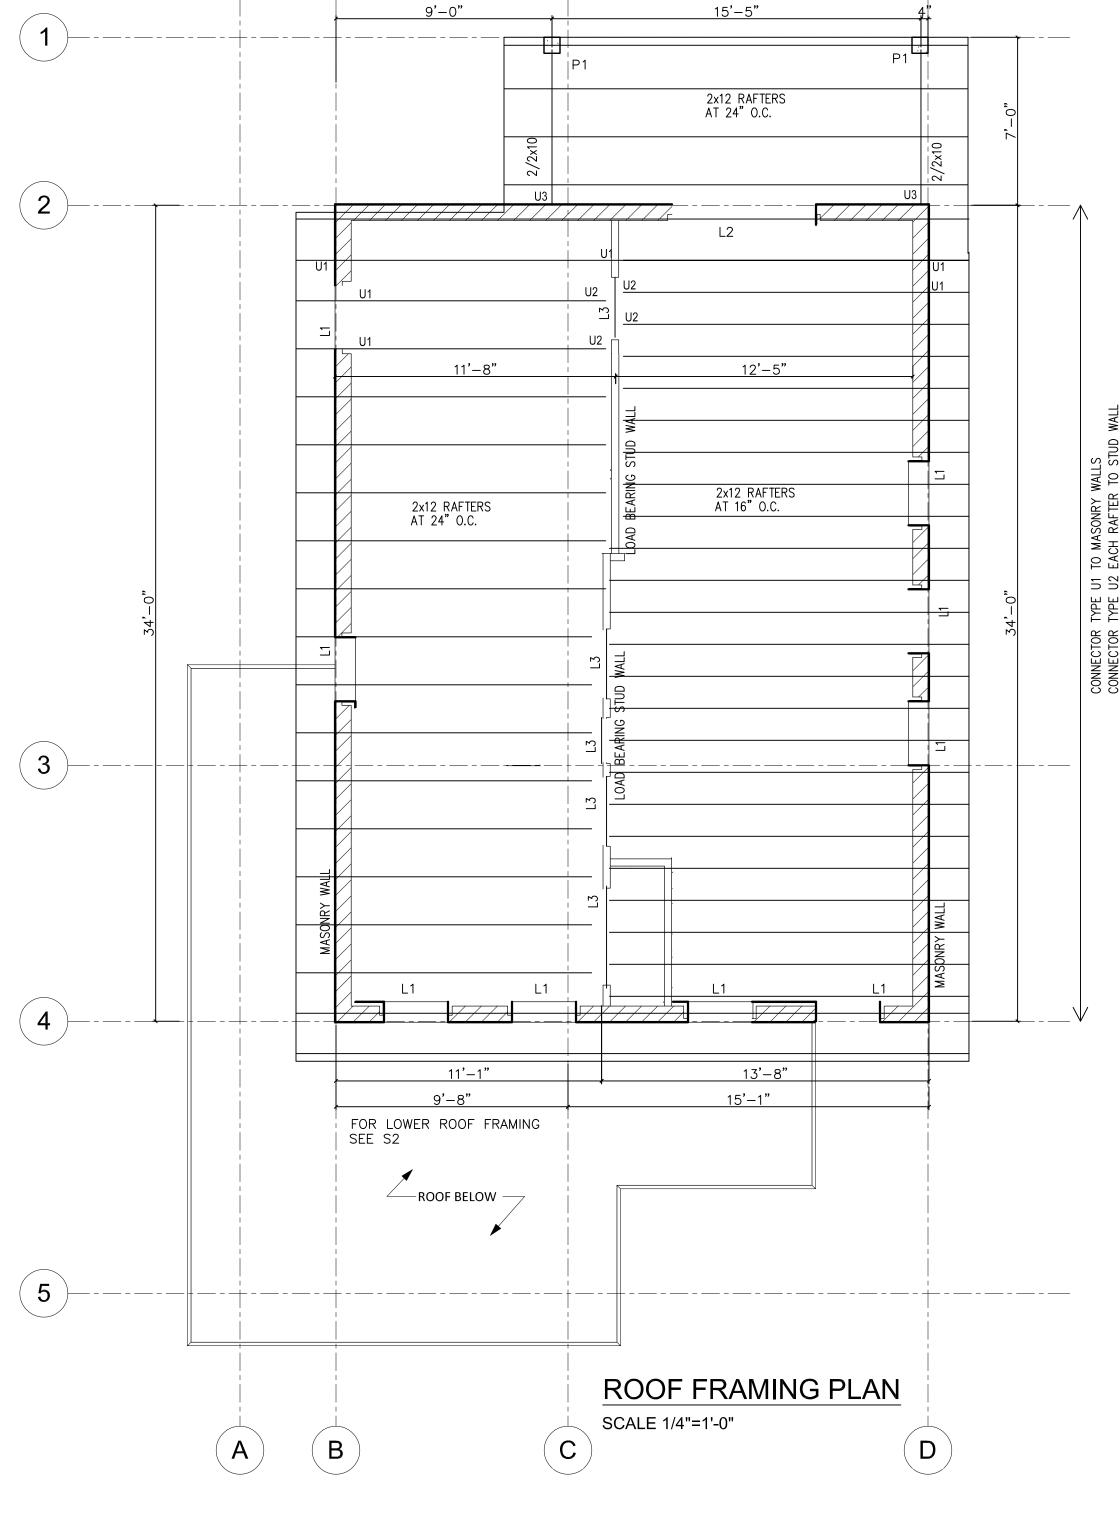

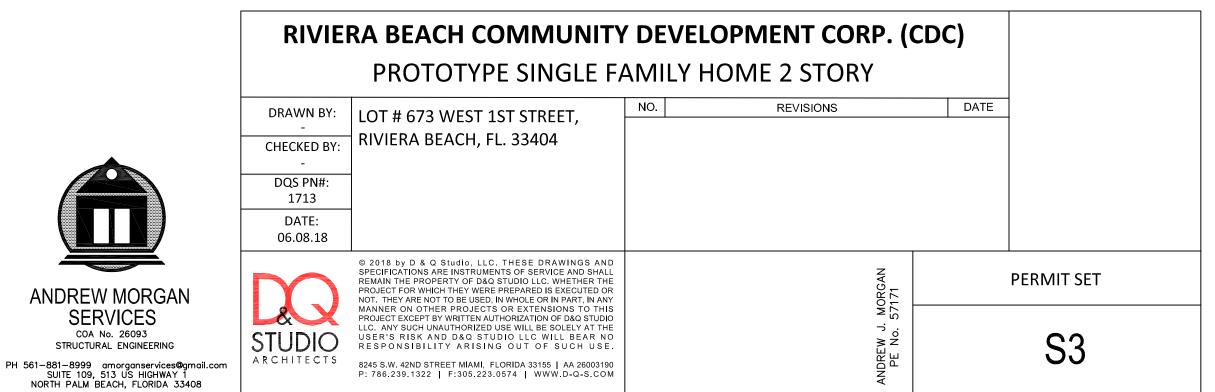

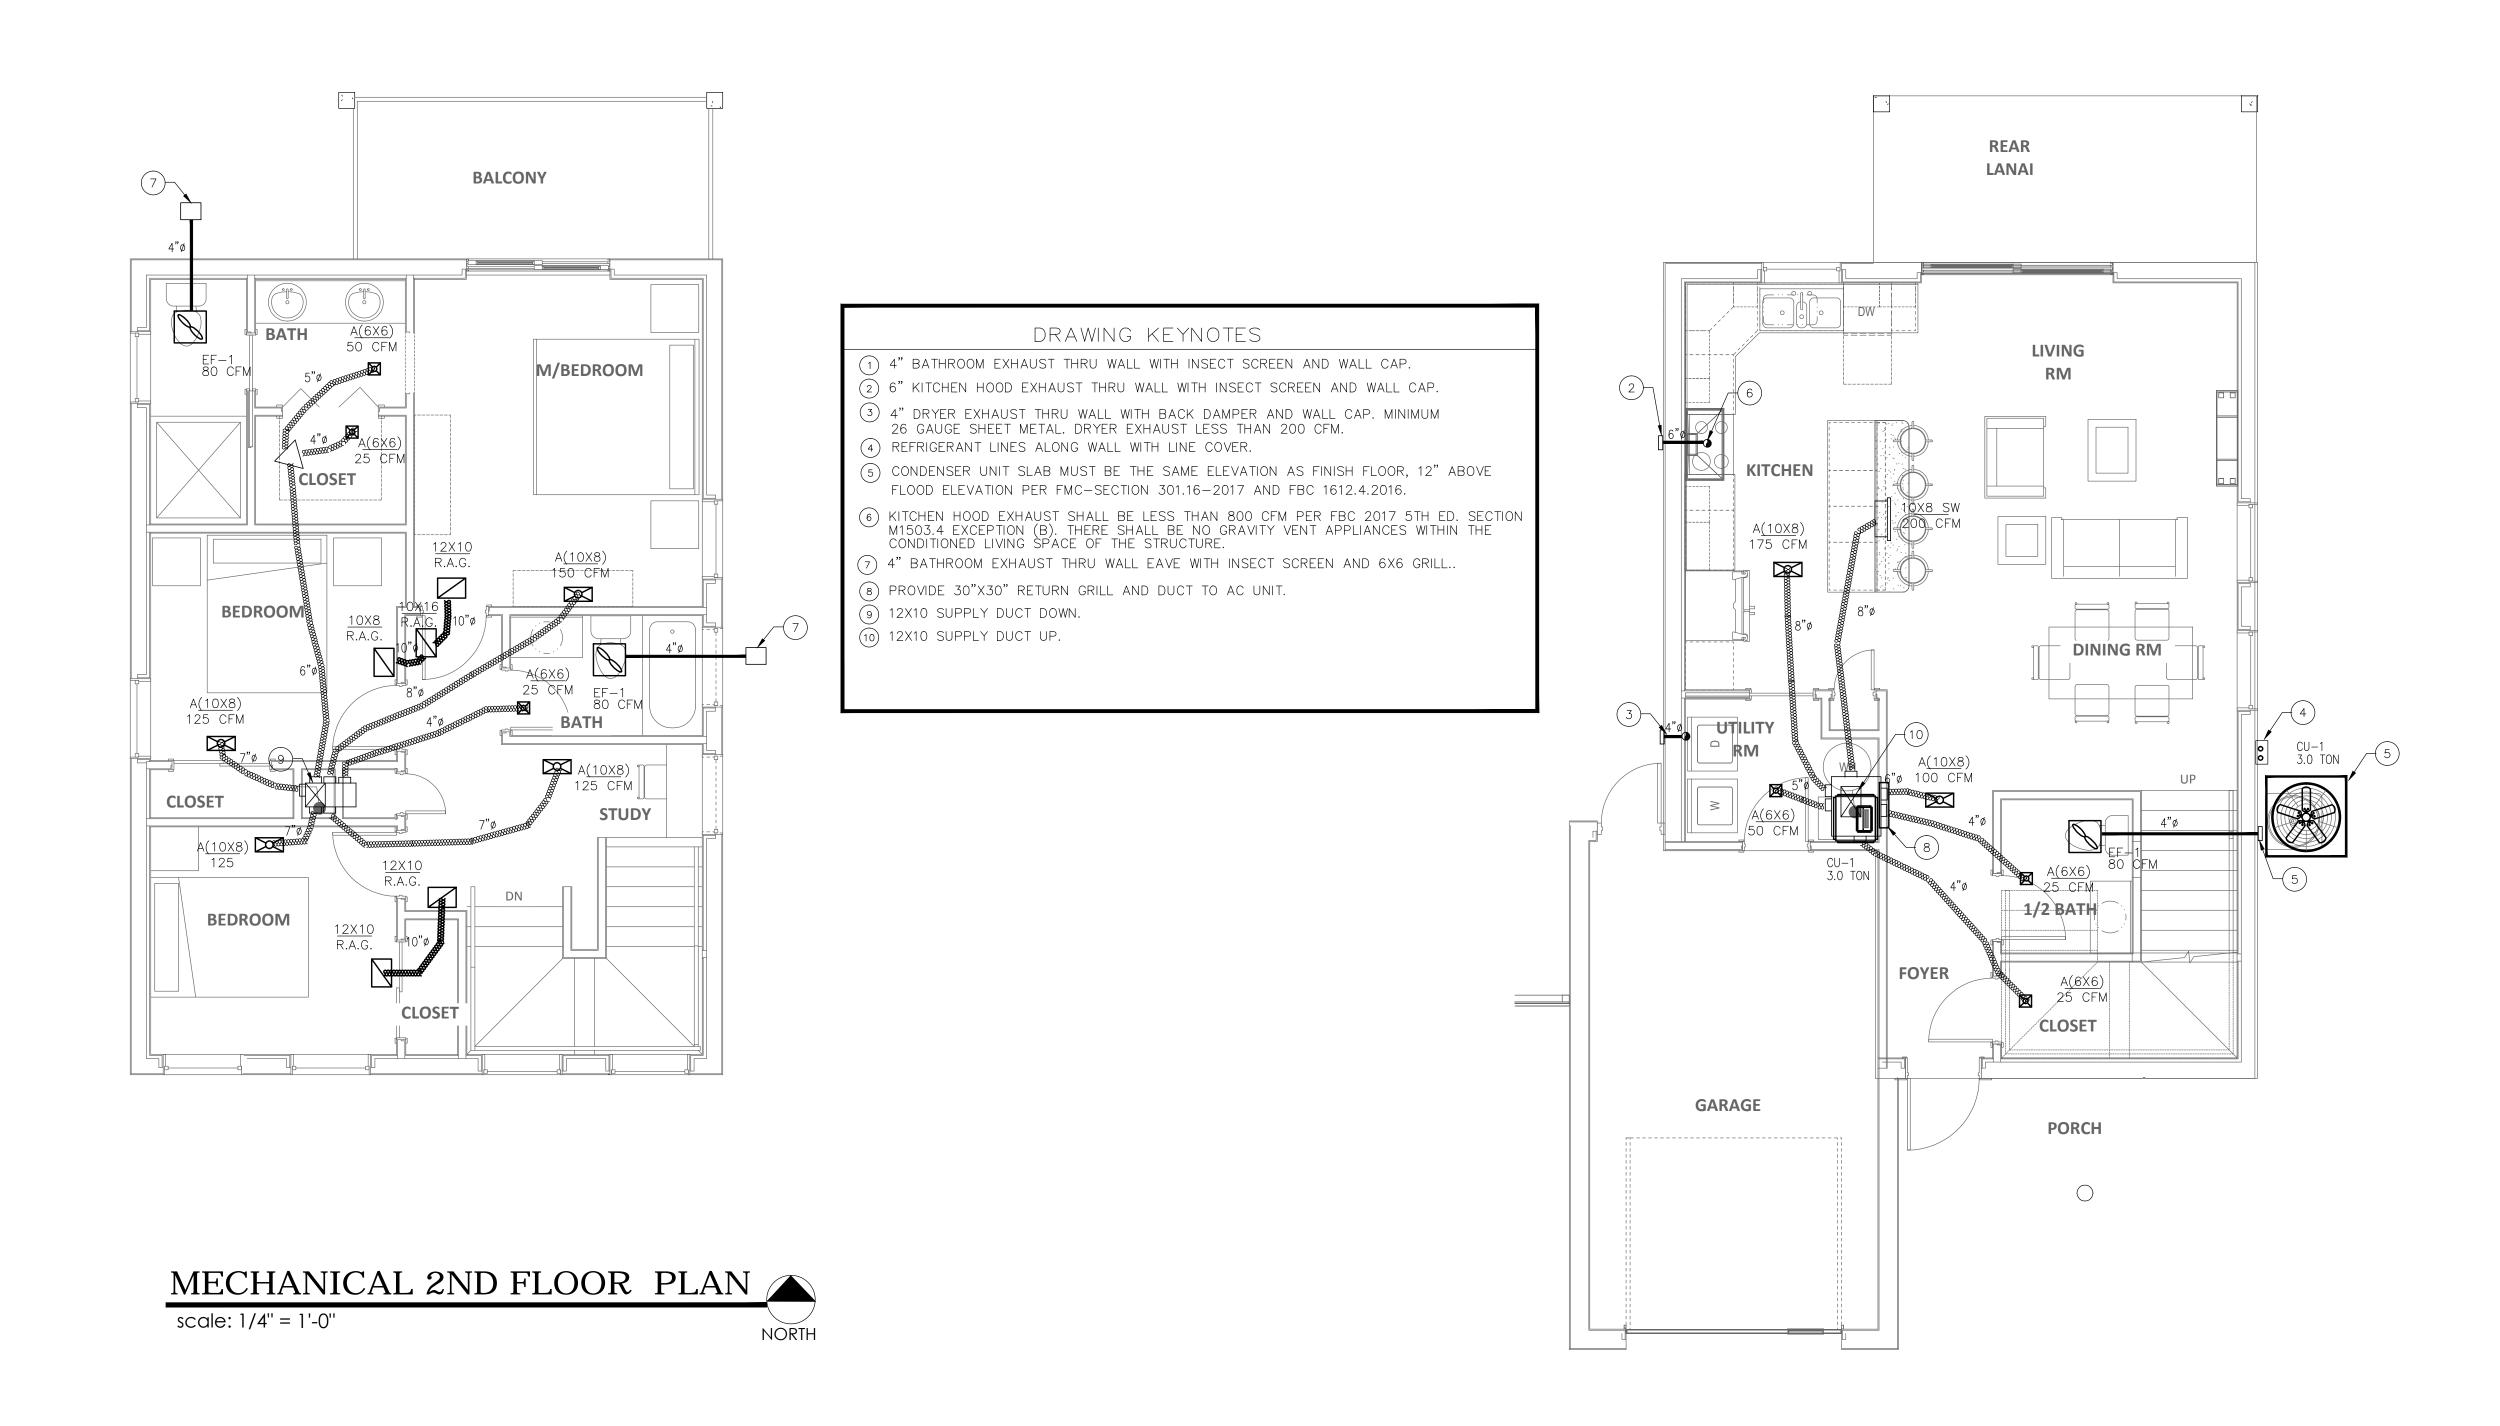




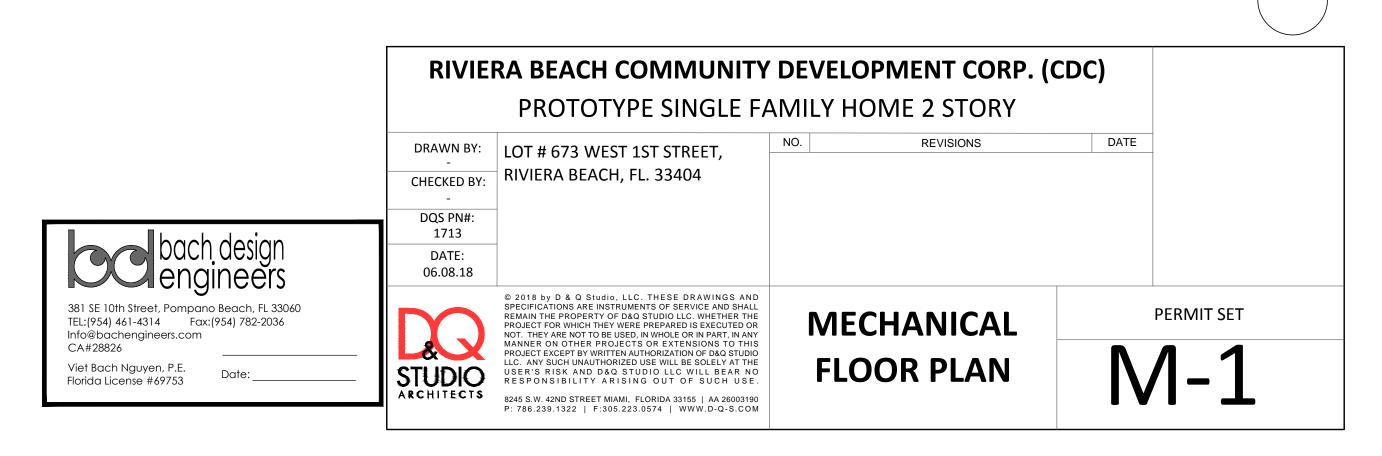

HVAC GENERAL NOTES

GENERAL

- A. ALL WORK SHALL BE DONE IN ACCORDANCE WITH THE FLORIDA
- BUILDING CODE (MECHANICAL 2017 6TH ED.) AND WITH ALL APPLICABLE REGULATIONS. DRAWINGS: REFER TO ALL DRAWINGS FOR COORDINATION OF THE HVAC WORK. C. ARRANGE AND PAY FOR ALL PERMITS LICENSES, INSPECTIONS AND TESTS.
- OBTAIN THE REQUIRED CERTIFICATES AND PRESENT TO OWNER. D. GUARANTEE: THE COMPLETED INSTALLATION SHALL BE FULLY GUARANTEED AGAINST DEFECTIVE MATERIALS AND/OR IMPROPER WORKMANSHIP FOR A MINIMUM OF ONE YEAR FOR MATERIAL AND LABOR. ALL COMPRESSORS SHALL BE GUARANTEED FOR 5 YEARS MINIMUM.
- 2. DESIGN PARAMETERS:
- A. INDOOR DESIGN TEMPERATURE (SUMMER): 78F DB B. INDOOR DESIGN TEMPERATURE (WINTER): 72F DB
- 3. ALL THERMOSTATS SHALL HAVE HEATING MODE MAXIMUM SETTING OF 75 F, AND COOLING MODE MINIMUM SETTING OF 70 F. THE THERMOSTAT SHALL BE ARRANGED TO PREVENT THE SIMULTANEOUS OPERATION OF HEATING AND COOLING.
- 4. ELECTRICAL CONTROLS AND POWER WIRING: UNDER ELECTRICAL CONTRACT.
- 5. EQUIPMENT SPECIFIED BY MANUFACTURER'S NUMBER SHALL INCLUDE ALL ACCESSORIES, CONTROLS, ETC., LISTED IN THE CATALOG AS STANDARD WITH THE EQUIPMENT. OPTIONAL OR ADDITIONAL ACCESSORIES SHALL BE FURNISHED AS
- 6. MATERIALS:
- A. REFRIGERANT PIPING: SHALL BE TYPE L SOFT DRAWN, COPPER TUBING, DEHYDRATED FOR REFRIGERANT USE. SIZED AS SHOWN ON DRAWINGS OR AS PER AIR CONDITIONING EQUIPMENT MANUFACTURER'S RECOMMENDATIONS.
- B. INSULATION: REFRIGERANT SUCTION PIPING AND CONDENSATE PIPES SHALL BE INSULATED WITH 3/4" THICK FOAMED PLASTIC INSULATION, FIRE RETARDANT TYPE. INSULATION SHALL BE INSTALLED IN PIPING BEFORE ASSEMBLY. NO SPLIT INSULATION WILL BE ACCEPTABLE. SEAL JOINTS WITH MANUFACTURER'S APPROVED ADHESIVE AND GREY TAPE.
- A. ALL SUPPLY AIR DUCTWORK SHALL BE 1" THICK FIBERGLASS DUCTBOARD, FABRICATED AND INSTALLED AS PER LATEST EDITION OF SMACNA "FIBROUS GLASS DUCT MANUAL". R-4.2 MIN.
- B. ALL OUTDOOR AND EXHAUST AIR DUCTWORK SHALL BE GALVANIZED SHEET METAL OR ALUMINUM DUCT NOT LIGHTER THAN 24 GAGE.
- C. ALL DUCT DIMENSIONS ARE CLEAR INSIDE DIMENSIONS. D. FLEXIBLE INSULATED DUCTWORK WITH 1-1/2" THICK FIBERGLASS
- INSULATION WITH FRK VAPOR BARRIER. $\hat{R}-6.0$ MIN. 7. CONTROLS: AIR CONDITIONING UNITS SHALL BE STARTED AND STOPPED THRU
- INDIVIDUAL PROGRAMMABLE THERMOSTAT. INDIVIDUAL THERMOSTATS SHALL START/STOP FANS AND ACTIVATE COOLING/HEATING SYSTEMS AS SELECTED.
- 8. ALL WORK SHALL BE COORDINATED WITH OTHER TRADES TO AVOID ANY INTERFERENCES THAT MAY DELAY PROGRESS OF CONSTRUCTION. CONTRACTOR SHALL INSTALL ALL NECESSARY OFFSETS, BENDS, AND TRANSITIONS REQUIRED TO PROVIDE A COMPLETE SYSTEM AT NO ADDITIONAL COST TO OWNER.

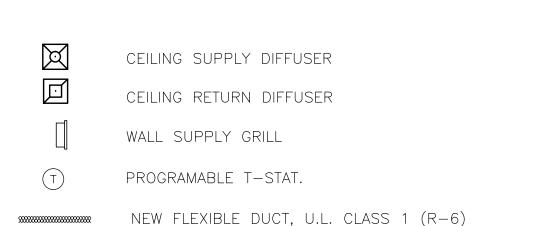



SPLIT SYSTEM SCHEDULE


AIR HANDLING UNIT									AIR COOLED CONDENSING UNIT						SYSTEM DATA									
MODEL	CFM	ESP	FAN	HEATER	₹	UNIT	MAX	WT	MARK	MODEL	WT	ELECTRICAL	COMPF	COMPRESSOR		SOR FAN		UNIT	MAX	CAPACI	TY	SEER	REF. L	INES
NO.	TOTAL		HP	кw	STEP	MCA	МОСР	LBS		NO.	LBS	VOLTS-PH-HZ	QTY.	TONS	RLA	QTY	FLA	MCA	МОСР	ТМВН	SMBH		SUCTION	LIQUID
TRANE TEM6A0C36	1200	0.4	1/2	9.6	1	55	60	150	CU-1	TRANE 4TTR6036	195	240-1-60	1	3.0	14.1	1	0.93	19	30	35.0	27.0	16.5	3/4	3/8


SPLIT SYSTEM NOTES:


- OUTSIDE AIR DESIGN CONDITIONS: 91°FDB 79°FDB.
- PROVIDE A/C UNITS WITH PROGRAMMABLE HEATING AND COOLING THERMOSTAT WITH ON-OFF SWITCH SUB-BASE. (WIRED AND INSTALLED BY ELECTRICAL CONTRACTOR)
- PROVIDE PROPER VIBRATION ISOLATORS AS PER ISOLATION MANUFACTURER'S RECOMMENDATIONS. PROVIDE FILTER RACK UNDER
- INSTALL CHEMICAL DRYER AND STRAINER IN REFRIGERANT LIQUID LINES. PROVIDE BUILT-IN DISCONNECT WITH ALL AIR HANDLING UNITS.
- 6. MATERIALS:
- A. REFRIGERANT PIPING: SHALL BE TYPE L SOFT DRAWN, COPPER TUBING, DEHYDRATED FOR REFRIGERANT USE. SIZED AS SHOWN ON DRAWINGS OR AS
- PER AIR CONDITIONING EQUIPMENT MANUFACTURER'S RECOMMENDATIONS. B. INSULATION: REFRIGERANT SUCTION PIPING AND CONDENSATE PIPES SHALL BE INSULATED WITH 3/4" THICK FOAMED PLASTIC INSULATION, FIRE RETARDANT TYPE. INSULATION SHALL BE INSTALLED IN PIPING BEFORE ASSEMBLY. NO SPLIT
- INSULATION WILL BE ACCEPTABLE. SEAL JOINTS WITH MANUFACTURER'S APPROVED ADHESIVE AND GREY TAPE.

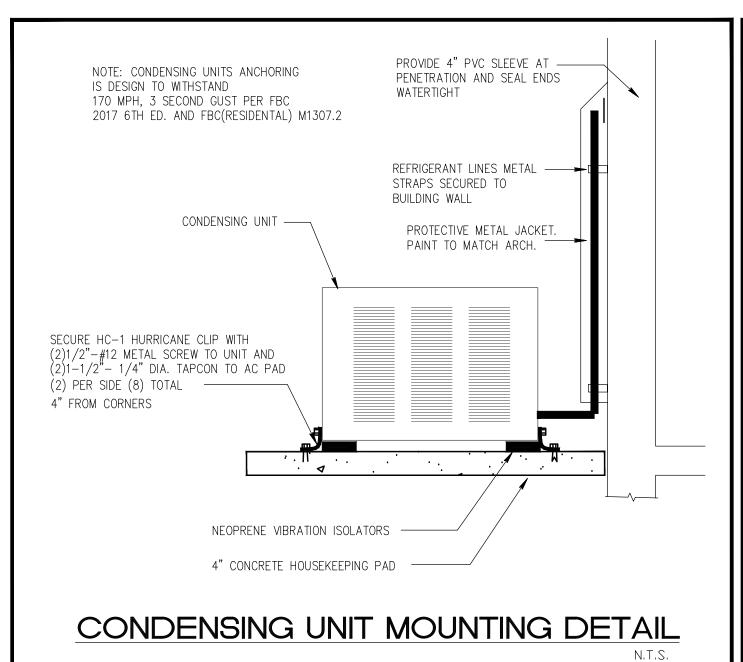

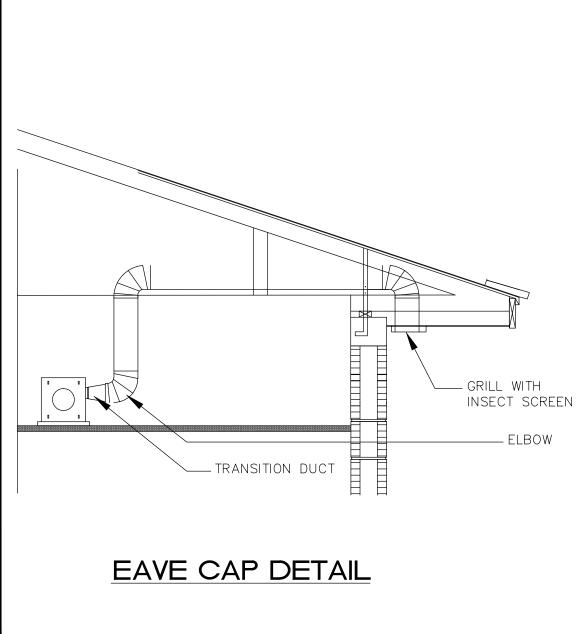

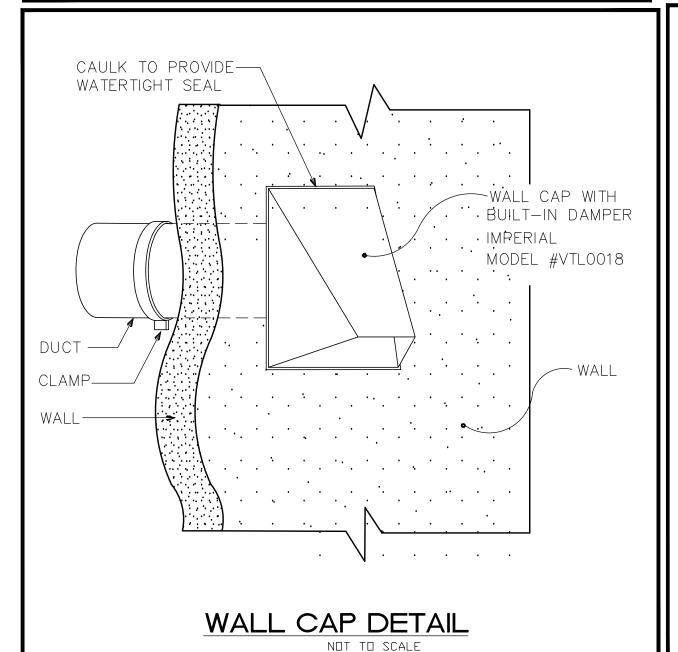

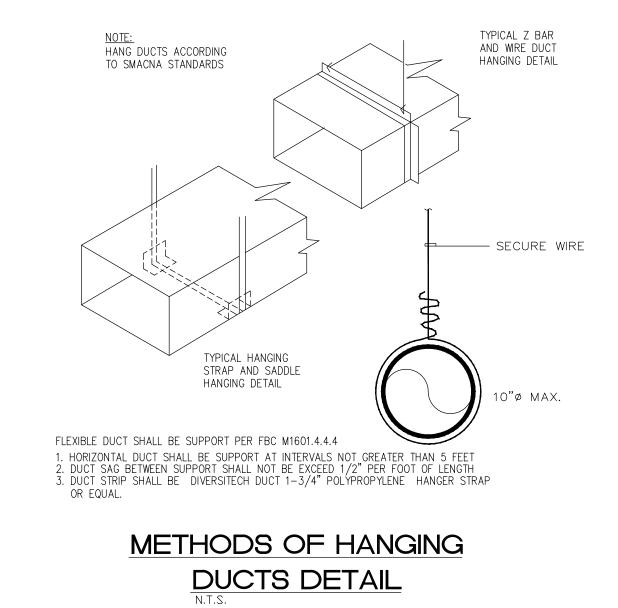

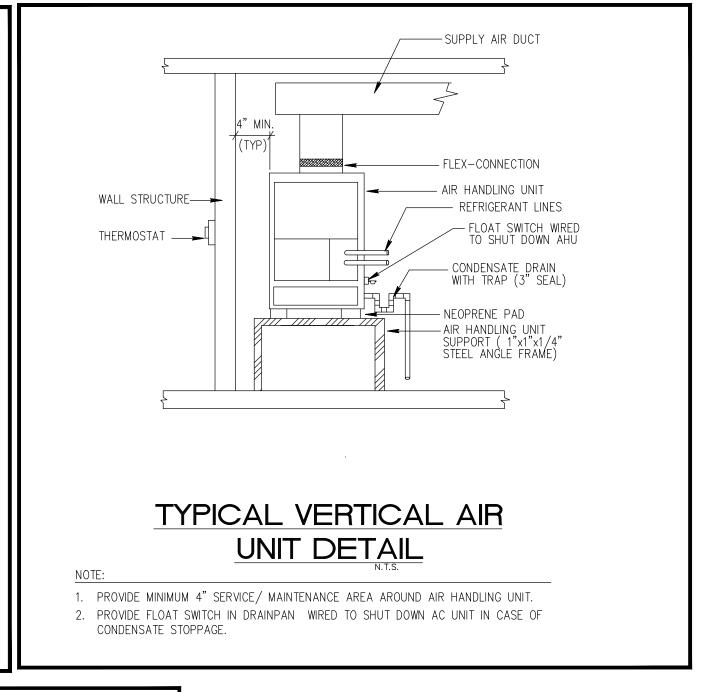

AIR DISTRIBUTION SCHEDULE

DIFFUSER TYPE CFM DIFFUSER CFM

TAG MANUFACTURER & MODEL NO. NOTES: 4-WAY ADJUSTABLE

ALUMINUM RETURN GRILL

OPPOSED BLADE DAMPER TITUS 250-AA ALUMINUM DIFFUSER

NOTES:

1. ALL GRILLS MUST BE APPROVED BY OWNER/ARCHITECT.

TITUS 300/350


FAN SCHEDULE


I	MARK	SELECTION BASED ON	LECTION BASED ON		CFM	MOTOR DATA			DRIVE	SONES	UNIT
		MAKE	MODEL NO.	SERVICE		WATTS	AMP	VOLTS-PH-HZ		□R NC	WEIGHT
	EF-1	PANASONIC	FV-08VK3	BATHROOM	80	7	-	120	DRIVE	0.3	12.1

GENERAL FAN NOTES:


- PROVIDE MOTOR STARTERS, DISDONNECTS AND ALL ASSOCIATED CONTROLS
- PROVIDE BACKDRAFT FOR ALL EXHAUST FANS . FIELD ADJUST OPENINGS WITH STRUCTURE.
- PROVIDE BIRDSCREEN ON ALL INLETS AND OUTLETS. SWITCH WITH LIGHTS

381 SE 10th Street, Pompano Beach, FL 33060 TEL:(954) 461-4314 Fax:(954) 782-2036 Info@bachengineers.com CA#28826 Viet Bach Nguyen, P.E. Florida License #69753

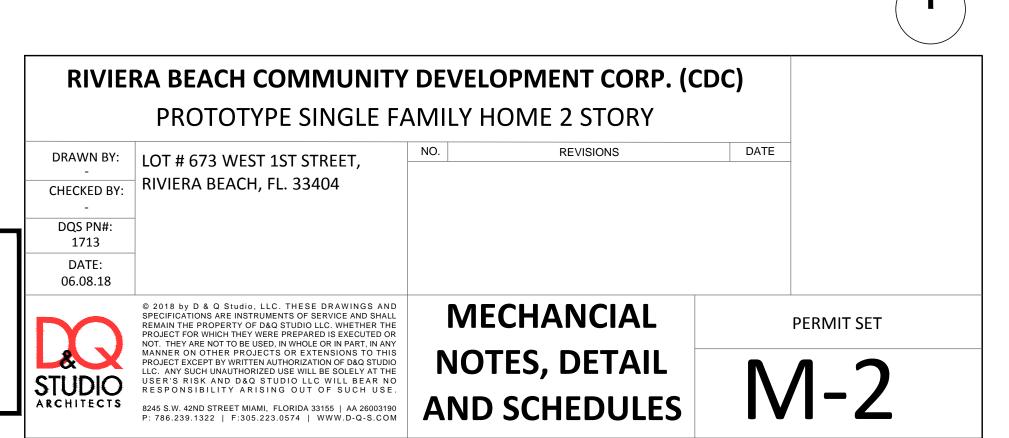

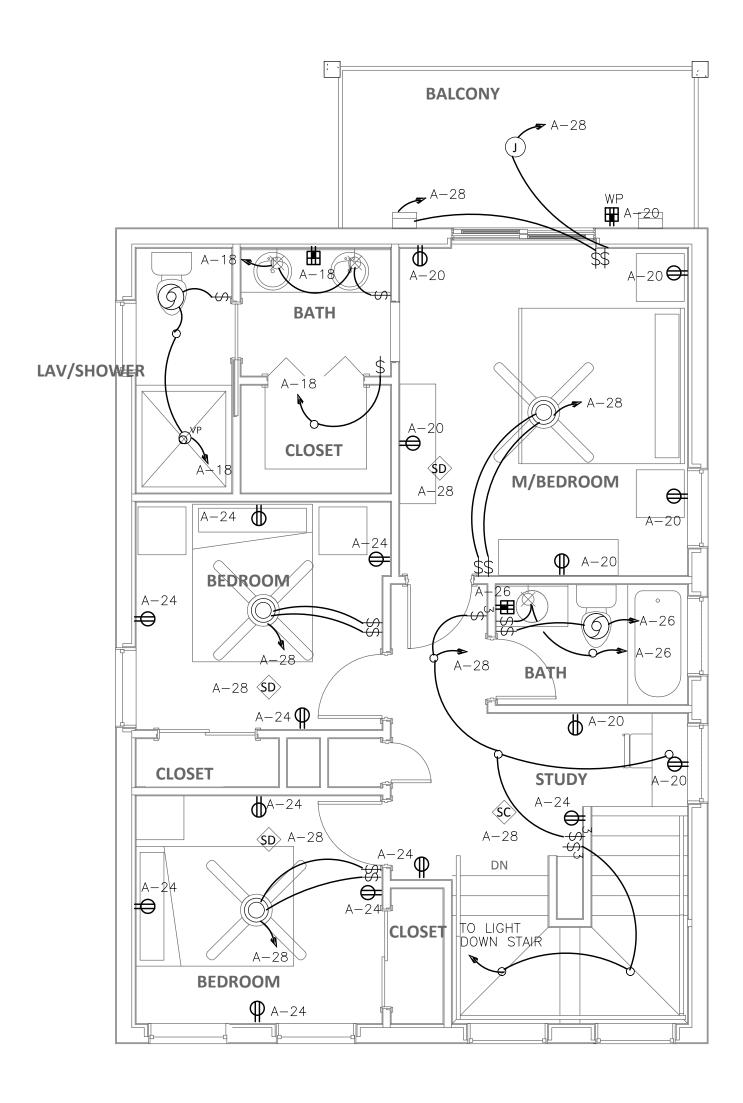



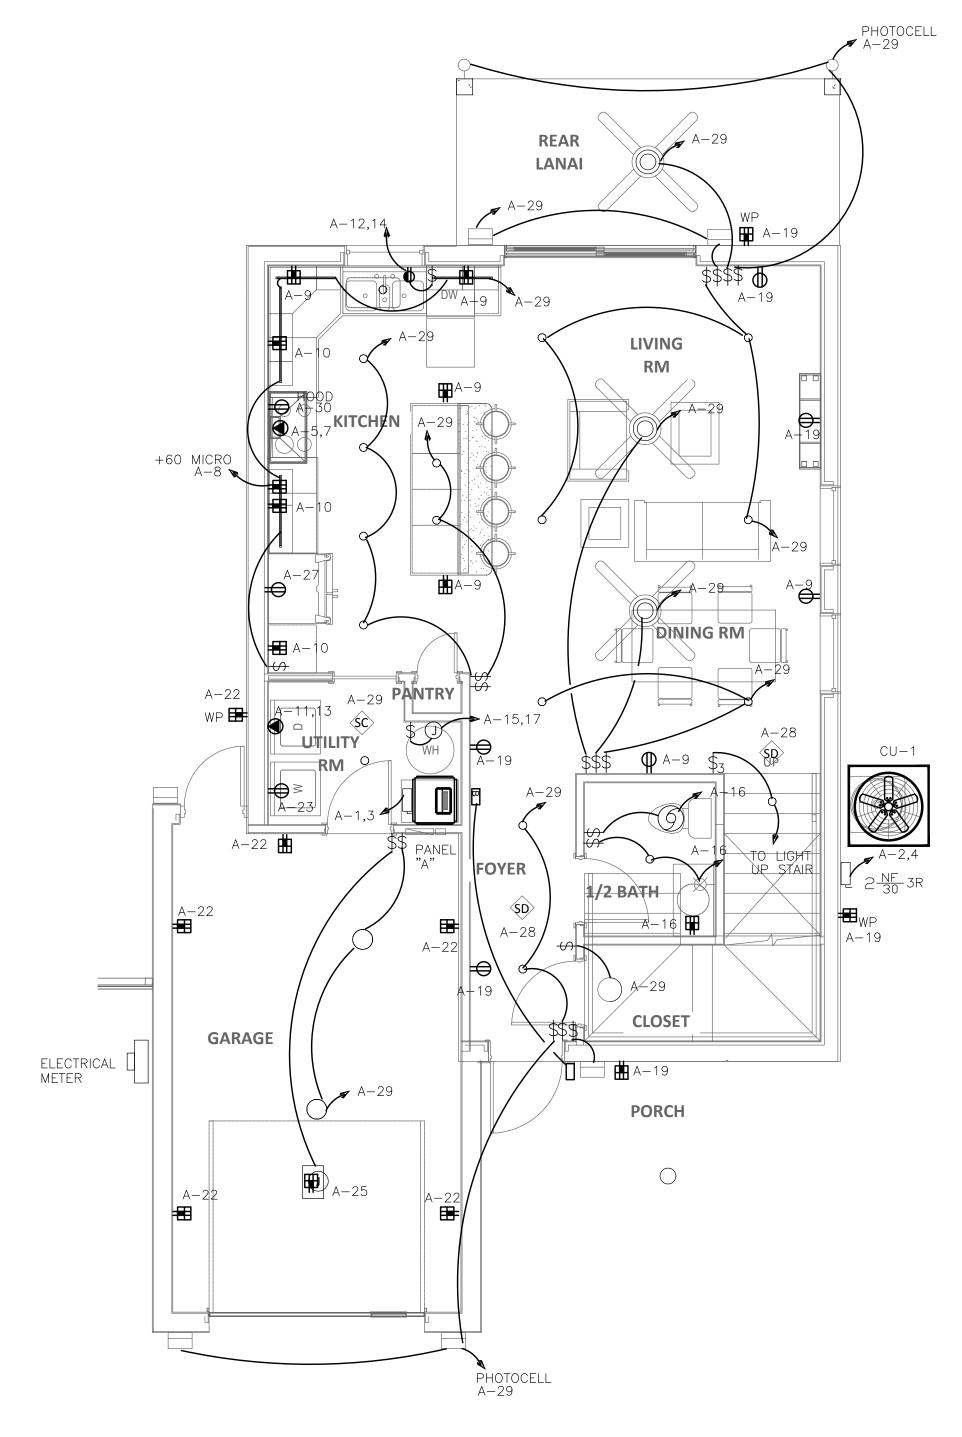




381 SE 10th Street, Pompano Beach, FL 33060


TEL:(954) 461-4314 Fax:(954) 782-2036 Info@bachengineers.com CA#28826

Viet Bach Nguyen, P.E. Florida License #69753

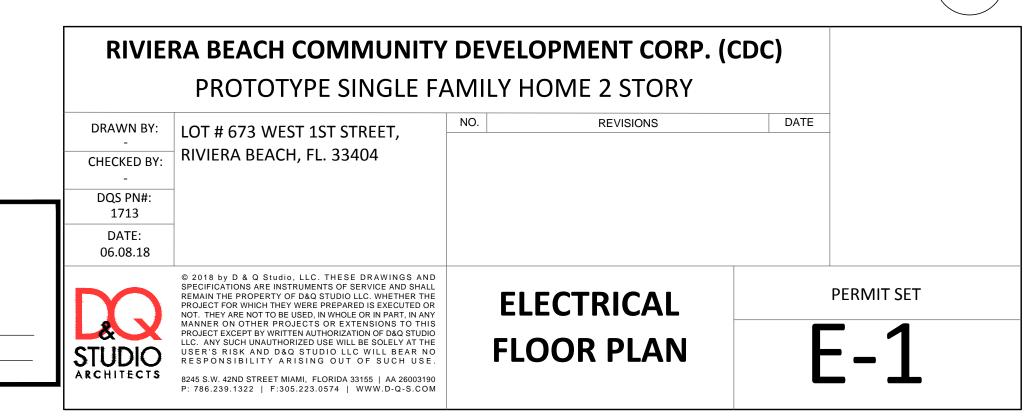

ELECTRICAL NOTES

- 1. ALL ELECTRICAL WORK SHALL BE PERFORMED IN ACCORDANCE WITH THE NATIONAL ELECTRICAL CODE 2014, FLORIDA BUILDING CODE 2017 6TH ED. AND/OR ANY LOCAL CODES
- 2. THE ELECTRICAL CONTRACTOR SHALL PAY ANY FEES, TAXES AND PERMIT FEES PERTAINING TO THE ELECTRICAL WORK.
- 3. THE ELECTRICAL CONTRACTOR SHALL REFER TO THE ARCHITECTURAL PLANS FOR LOCATION OF ALL EQUIPMENT. CONTRACTOR SHALL NOT SCALE PLANS.
- 4. IT IS NOT THE INTENT OF THESE PLANS TO SHOW EVERY AND ALL DETAILS OF CONSTRUCTION. THE ELECTRICAL CONTRACTOR SHALL FURNISH AND INSTALL ALL ITEMS AS TO PROVIDE A COMPLETE ELECTRICAL INSTALLATION WITH ALL EQUIPMENT IN PROPER WORKING ORDER.
- 5. THE ELECTRICAL CONTRACTOR SHALL BE RESPONSIBLE FOR THE FULL COORDINATION OF HIS WORK WITH THAT OF THE GENERAL CONTRACTOR AND ALL OTHER SUB-CONTRACTORS.
- 6. IT SHALL BE UNDERSTOOD THAT ALL WORK PERFORMED SHALL BE DONE SO BY A LICENSED ELECTRICAL CONTRACTOR AND IN A FIRST CLASS WORKMANLIKE MANNER. 7. ALL ELECTRICAL WORK AND MATERIAL SHALL BE GUARANTEED FOR A PERIOD OF ONE
- YEAR FROM DATE OF ISSUE OF CERTIFICATE OF OCCUPANCY AND AS BY CONTRACT W/ OWNER. 8. ALL POWER AND CONTROL WIRING SHALL BE DONE BY THE ELECTRICAL CONTRACTOR. 9. NOT USED
- 10. ALL EXTERIOR CIRCUITS SHALL BE IN PVC CONDUIT PROVIDED WITH A GREEN GROUND WIRE. 11. ALL DISCONNECT SWITCHES SHALL BE FUSED WITH CURRENT LIMITING FUSES. VERIFY
- FUSE SIZE WITH EQUIPMENT'S NAME PLATE WHERE APPLICABLE 12. ALL PANELS SHALL HAVE TYPEWRITTEN DIRECTORIES INDICATING ALL CRCUITS.
- 13. THE ELECTRICAL CONTRACTOR SHALL PROVIDE AND INSTALL PLUGS AND CORDS AT ALL APPLIANCES INDICATED ON PLANS AND SCHEDULES.
- 14. ALL CONTRACTORS RESPONSIBLE FOR GENERATOR POWER. 15. ALL WIRES AND CABLES SHALL BE COPPER EXCEPT AS INDICATED.
- 16. FLEXIBLE WIRE CONNECTION TO C.U. SHALL NOT EXCEED 3 FT. IN LENGTTH.
- 17. CONTRACTOR SHALL PROVIDE LIGHTING FIXTURES AND AS PER LIGHTING FIXTURE SCHEDULE AND OBTAIN OWNER APPROVAL PRIOR TO SUBMITTING SHOP DRAWINGS. 18. NOT USED
- 19. ALL WIRE SIZES INDICATED ARE BASED THE USE OF COPPER CONDUCTORS. AT THE DEVELOPER'S OPTION ALUMINUM CONDUCTORS MAY BE USED FOR FEEDERS AND SERVICES WHERE THE FOLLOWING CONDITIONS ARE ADHERED TO:
- A. MINIMUM SIZE OF ALUMINUM SHALL BE #1 AWG (100A) B. ALL TERMINATIONS SHALL BE MADE WITH COMPRESSION TYPE FITTINGS.
- C. CONDUIT SIZES SHALL BE INCREASED ACCORDINGLY IN ORDER TO ACCOMODATE THE USE OF LARGER CONDUCTOR.
- D. GROUND CONDUCTORS SHALL NOT BE ALUMINUM.
- E. ALUMINUM CONDUCTORS SHALL NOT BE USED FOR BRANCH CIRCUIT WIRING. 20. TIME SWITCHES SHALL BE 120V, 24 HOUR ASTRONOMIC DIAL AS APPROVED BY DESIGNER.
- 21. ALL SMOKE DETECTORS SHOULD BE INTERCONNECTED. IN COMMON AREAS & SMOKE DETECTORS SHALL BE A COMBINATION IONIZATION / PHOTO ELECTRIC TYPE.
- 23. CONTRACTOR SHALL COORDINATE FUSE AND CKT. BREAKER SIZE AS PER EQUIPMENT NAME PLATE PRIOR TO ROUGH-IN CONTRACTOR SHALL COORDINATE WITH MECHANICAL
- CONTRACTOR SHOPDRAWINGS. 24 DRYER AND RANGE RECEPTACLES SHALL BE 120/240V, 10 4 WIRE TYPE. (PER NEC
- 25. LIGHT SWITCHES, OUTLETS, THERMOSTATS IN ACCESSIBLE LOCATIONS. NO HIGHER THAN 48" AND NO LOWER THAN 15" ABOVE THE FINISH FLOOR AND 44" WHERE BASE CABINETS. 26. EQUIPMENT GROUNDING CONDUCTOR IN WET LOCATIONS SHALL BE COOPER.
- 27. NOT USED 28. ALL BRANCH CIRCUITS THAT SUPPLY 120V, 10, 15AMP & 20AMP OUTLETS SHALL BE PROTECTED BY COMBINATION TYPE ARC-FAULT CIRCUIT INTERRUPTERS LISTED TO PROVIDE PROTECTION OF THE ENTIRE BRANCH CIRCUIT AS PER NEC 2014 210-12(A).
- 29. ALL 15A AND 20A, 125V RECEPTACLES SHALL BE LISTED AS TAMPER RESISTANT (NEC 2014 406.12): IN EVERY KITCHEN, FAMILY ROOM, DINING ROOM, LIVING ROOM, DEN, SUNROOM, BEDROOM, BATHROOM, LAUNDRY AND OUTDOOR AREA PER 551.71: ALL 125V, 12&25 AMP RECEPTACLES TO
- 30. ALL SMALL APPLIANCE RECEPTACLES DEDICATED TO SERVE COUNTERTOP SURFACES IN KITCHEN SHALL BE GFCI PROTECTED IN ACCORDANCE WITH NEC 2014 210-53(B). OUTLET SPACING FOR THE COUNTER-TOP SURFACES SHALL COMPLY WITH (2014 NEC) 210.52(B)(C)
- 31. SINGLE STATION 110V SMOKE DETECTORS WITH A SOUNDER BASE AND BATTERY BACK-UP. SMOKE DETECTORS SHALL BE INTERCONNECTED SO THAT OPERATION OF ANY SMOKE DETECTOR SHALL ACTIVATE ALL SMOKE ALARMS WITHIN THE DWELLING UNIT. CONNECT TO LIVING ROOM LIGHTING CIRCUIT. AFCI TYPE CIRCUIT. LOCATE ALL SMOKE DETECTORS A MINIMUM OF 3'-0" FROM ALL RETURN AIR AND SUPPLY AIR GRILLES AND DIFFUSERS.
- ALL STATIONS SHOWN OUTSIDE THE SLEEPING ROOMS SHALL BE AC WIRE-IN COMBINATION CARBON MONOXIDE & SMOKE ALARM WITH BATTERY BACKUP AND INDEPENDENT CO AND SMOKE SENSORS. LOCATE ALL COMBINATION CARBON MONOXIDE & SMOKE ALARM WITHIN 10'-0" OF EACH SLEEPING
- 32. ISLAND RECEPTACLE SHALL BE MOUNTED NOT MORE THAN 12" BELOW THE COUNTERTOP. THE RECEPTACLE SHALL BE LISTED FOR THE APPLICATION.
- 33. RECEPTACLES FOR HOOD AND MICROWAVE CONNECTION. FIELD COORDINATE EXACT LOCATION P
- PRIOR TO ROUGH IN. 34. ALL CONDUIT RUNS SHALL BE CONCEALED INSIDE WALL.
- 35. CHIME SHALL CONNECT TO PUSH BUTTON AT THE MAIN ENTRANCE. COORDINATE WIRING REQUIREMENTS WITH CHIME MANUFACTURER PRIOR TO BID/ROUGH IN

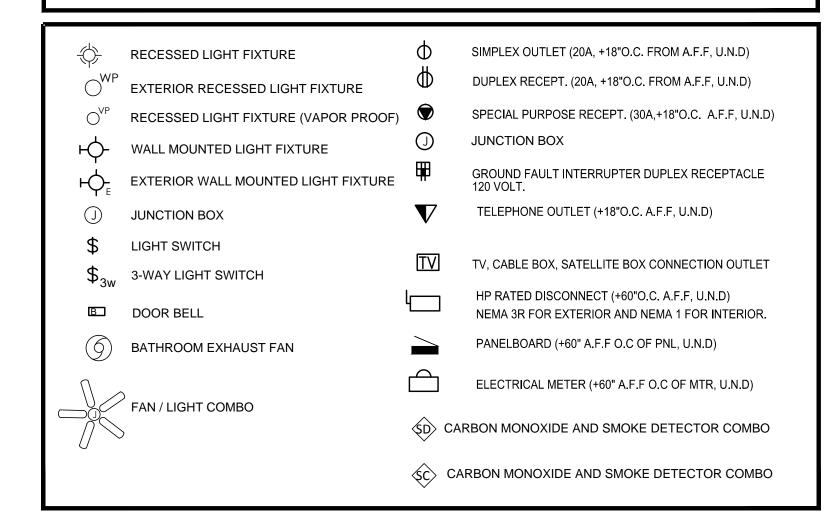


- A MINIMUM OF 75% OF THE PERMANENTLY INSTALLED LIGHTING FIXTURES SHALL CONTAIN ONLY HIGH EFFICACY LAMPS AS PER FBC 2017 R404.1 - RECESSED LUMINAIRES INSTALLED IN BUILDING THERMAL ENVELOPE SHALL BE IC-RATED AN LABELED AS PER FBC 2017 R402.4.5.


SENERAL NOTES:

- . ALL BRANCH CIRCUITS THAT SUPPLY 120V, 10, 15AMP & 20AMP OUTLETS SHALL BE PROTECTED BY COMBINATION TYPE ARC-FAULT CIRCUIT INTERRUPTERS LISTED TO PROVIDE PROTECTION OF THE ENTIRE BRANCH CIRCUIT AS PER NEC 2014 210-12(B).
- 2. ALL 15A AND 20A, 125V RECEPTACLES SHALL BE LISTED AS TAMPER RESISTANT (NEC 2014 406.11): IN EVERY KITCHEN, FAMILY ROOM, DINING ROOM, LIVING ROOM, DEN, SUNROOM, BEDROOM, BATHROOM, LAUNDRY AND OUTDOOR AREA.
- 3. ALL SMALL APPLIANCE RECEPTACLES DEDICATED TO SERVE COUNTERTOP SURFACES IN KITCHEN SHALL BE GFCI PROTECTED IN ACCORDANCE WITH NEC 2014 210-8(A)(6). OUTLET SPACING FOR THE COUNTER-TOP SURFACES SHALL COMPLY WITH 2014 NEC 210.52(B)(C)
- 4. SINGLE STATION 110V SMOKE DETECTORS WITH A SOUNDER BASE AND BATTERY BACK-UP. SMOKE DETECTORS SHALL BE INTERCONNECTED SO THAT OPERATION OF ANY SMOKE DETECTOR SHALL ACTIVATE ALL SMOKE ALARMS WITHIN THE DWELLING UNIT. CONNECT TO LIVING ROOM LIGHTING CIRCUIT. AFCI TYPE CIRCUIT. LOCATE ALL SMOKE DETECTORS A MINIMUM OF 3'-0" FROM ALL RETURN AIR AND SUPPLY AIR GRILLES AND DIFFUSERS.
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- 5. ALL RECEPTACLES AND SWITCHES IN OUTDOOR KITCHEN AND LIVING SPACE SHALL HAVE OUTDOOR RATED COVER PER NEC 406.9 AND 404.4


NM= NON-METALLIC SHEATHED CABLE

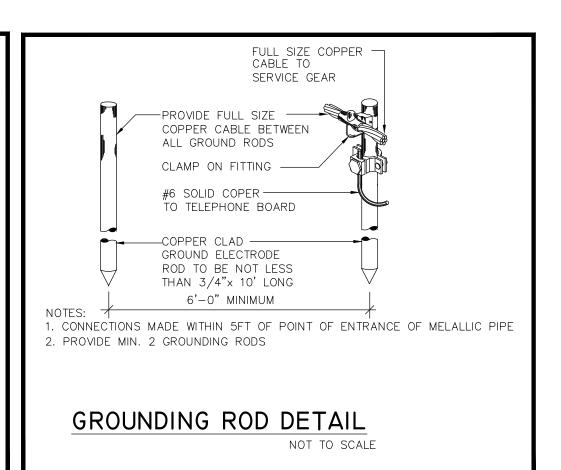

CKT. LOAD I	DESCRIPTION	1/2/	WIRE	GRD.	COND.	POLE/ TRIP	KVA A PHASE		KVA PHASE	POLE/	COND.	GRD.	WIRE	COPPER LOAD DE			C
1 AHU-1	DESCRIPTION \	++				2/60	5.3		PHASE	†					SUKIP III	JN	
3		Ш	6	6	NM	2/60		5.3	4)	2/20	NM	12	12	CU-1			
5 7 RANGE			6	6	NM	2/60	4.0 0.9		1.3	15 20	NM NM	12 12	12 12	AR MICROWAVE			
9 SMALL APPL	IANCE	(AF)	12	12	NM	20	1.5 1.5		1.3	20	NM	12	12	AF MICROWAVE AF SMALL APPLI	ANCE		+
11 DRYER			12	12	NM	2/30			1.2	20	NM	12	12	AF DISHWASHER			
13		$\perp \perp \perp$		<u> </u>	INIVI	2/30	2.5 .9		- 1 (2)	20	NM	12	12	AF GARAGE DISP			
15 WATER HEA	TER		12	12	NM	2/30	2.25 (2)		5 2	20	NM NM	12 12	12 12	(AF) POWER ROOM (AF) MASTER BATH			
19 FAMILY REC	PT.	(AF)	14	14	NM	15	2.23 (2)) (2)	15	NM	14		AF MASTER BR./		RECPT.	
	AND 17 RECPT.	(AF)	14	14	NM	15	2			20	NM	20	20	GARAGE RECP	ΥT.		
23 WASHER			12	12	NM	20		1.2		15	NM	14 20	14 20	AF BEDROOMS RE		20014	
25 GARAGE DOG 27 REFRIGERATO		(3) (AF)	12 12	12 12	NM NM	20 20	1.2 (2)	1.1	2	20	NM NM	20	20	AF SECOND FLOO			
29 FIRST FLOOF		(AF)	14	14	NM	15	1.2 (2)	(2)	8.	20	NM	20	20	(AF) HOOD	JIV LIGITI	IIIVG	
31 SPACE														SPACE			
33 SPACE		+												SPACE			
35 SPACE 37 SPACE		+												SPACE SPACE			
39 SPACE		+												SPACE			
41 SPACE		\top	-											SPACE			
	IONS ARE BASED ON: T	Y		TOTAL	KVA IS AMPERES		REFER T	O ^t load Calcula O Load Calcula	ATIONS	- (sī) S⊦		P GF G	ROUND	FAULT DE DEDICAT			D (
	= 120/240 VOLT	<u>S</u> 1	I PHAS	<u>E</u>	3 WIF	RE I	EQPT.	GRD. □ ISOL. (GRD.	MAIN			M.L.O.				
RATED VOLTAGE=			ER DIA	.GRAM				□BUSWAY		BRAN	CH POLE	S: 24	В	BRANCH BREAKERS=	= 10	KAIC	
RATED VOLTAGE= FEEDER SIZE IS:	CABLE = SE	E RIS				E CTANE	INC F	☐ KEYED DOOF	2	BUS	RATING:	150	A B	BRACING =	10	KAIC	
	■ CABLE = SE ■ SURFACE] FLUSH		☐ FRE	L STAINL	/1110										
FEEDER SIZE IS:	SURFACE] FLUSH ■ FULL S			ATED (1.		☐ K RATED (2.0)		GROU	ND BAR		EQUIPM	IENT □ ISOLATED	□ во	TH	
FEEDER SIZE IS: MOUNTING:	SURFACE			SIZE		ATED (1.		□ K RATED (2.0))		ND BAR LOCATI			IENT □ ISOLATED ■ BOTTOM		TH D THRU	

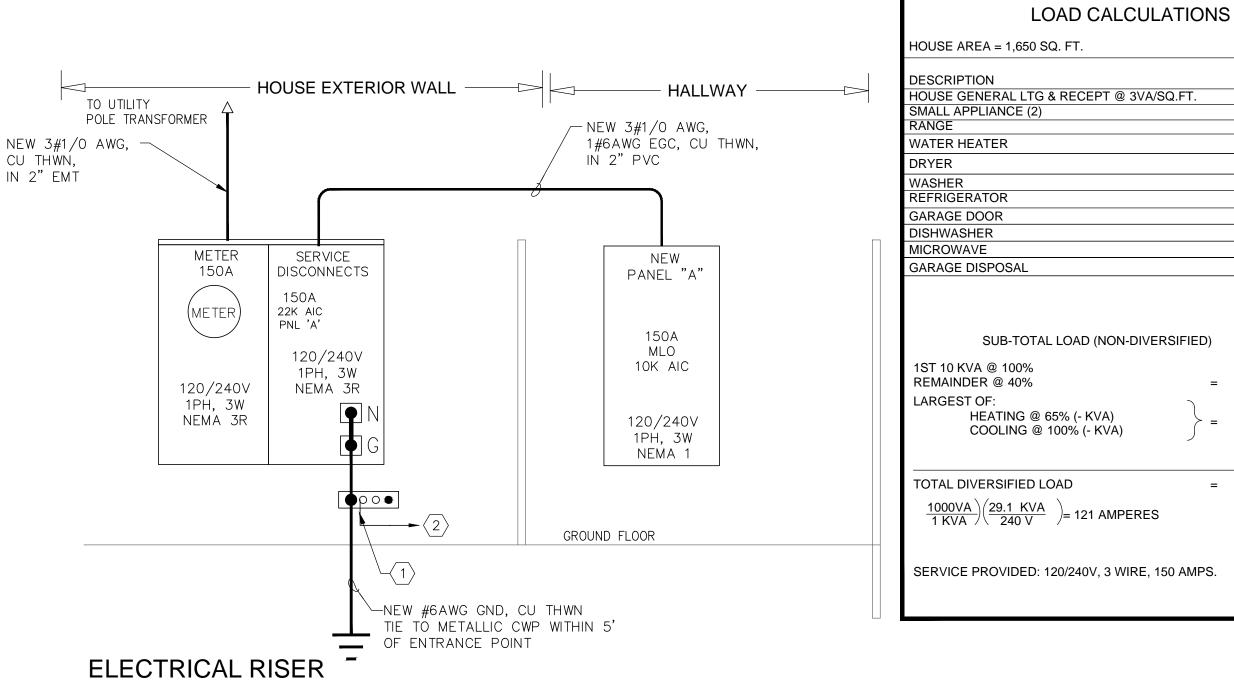

NOTES: $\langle \# \rangle$. INTERSYSTEM GROUNDING BRIDGE W/ CONDUIT ADAPTER AND PROTECTION COVER, ARLINGTON MDL# GBB50P (UL LISTED), OR APPROVED EQUAL 2. TIE TO PHONE/CATV UTILITY CABINET . PROVIDE WARNING TAPE

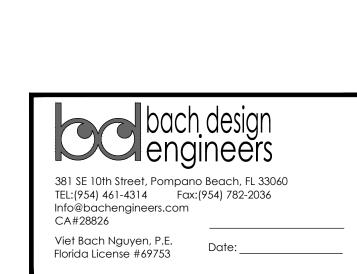

LOAD (KVA

4.5


32.7

10.0 KVA


10.0 KVA

= 9.1 KVA

= 29.1 KVA

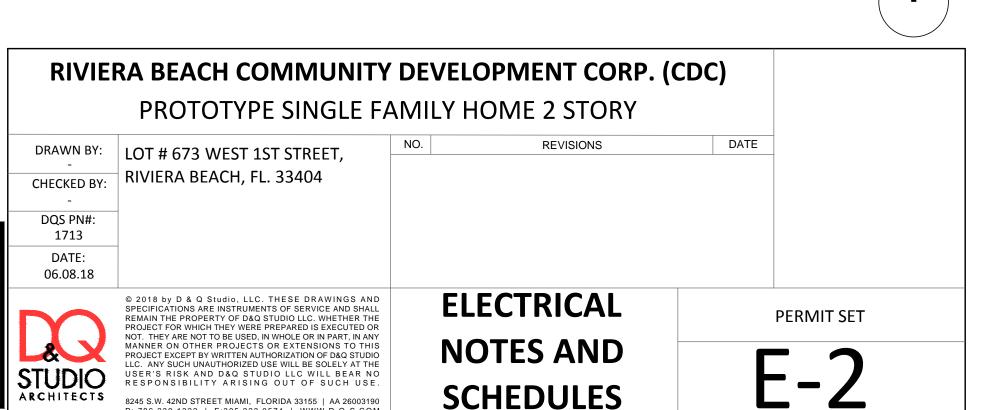


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PLUMBING KEY NOTES

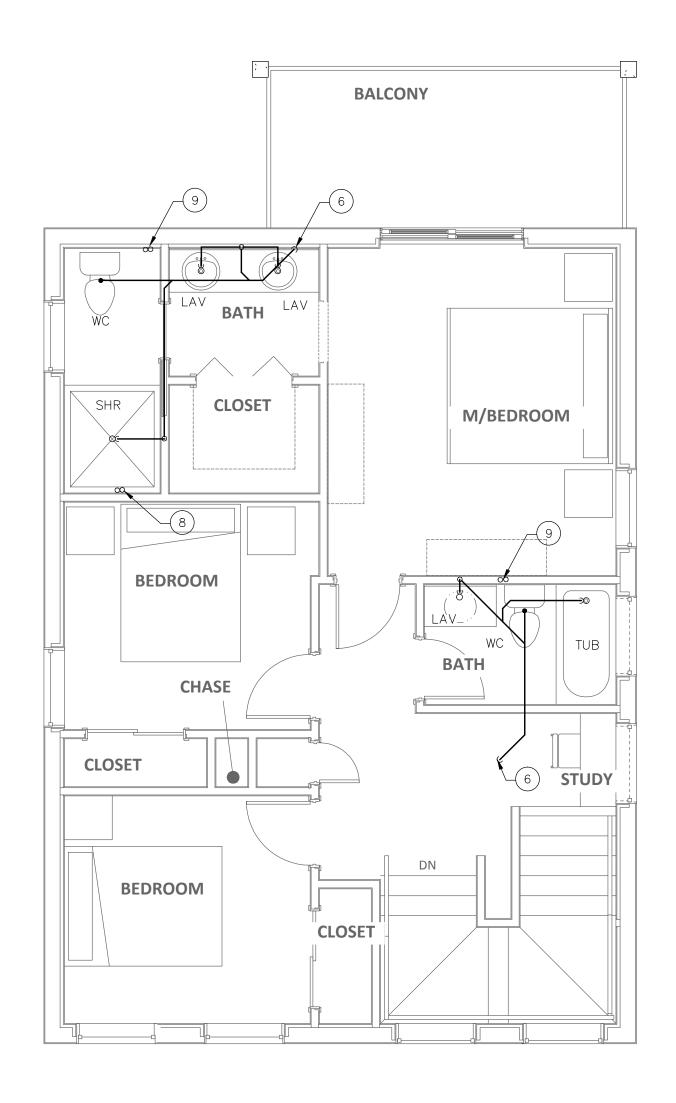- 1) TIE NEW 4" SANITARY TO EXISTING. CONTRACTOR TO FIELD VERIFY EXACT LOCATION.
- 2 TIE NEW 1" CW TO NEW METER. CONTRACTOR TO FIELD VERIFY EXACT
- (3) 60 GALLON WATER HEATER. (4.5KW @ 240V, EF0.96)
- (4) 2" CONDENSATE SPILL TO GRADE IN GREEN AREA 12" FROM BUILDING.
- (5) 1" DRAIN PAN DISCHARGED TO OUTSIDE.
- (6) 3" SANITARY DOWN (7) 3" SANITARY UP
- (8) 1/2" HW AND CW DOWN
- 9) 1/2" HW AND 3/4" CW DOWN
- 1/2" HW AND CW UP
- 1) 1/2" HW AND 3/4" CW UP





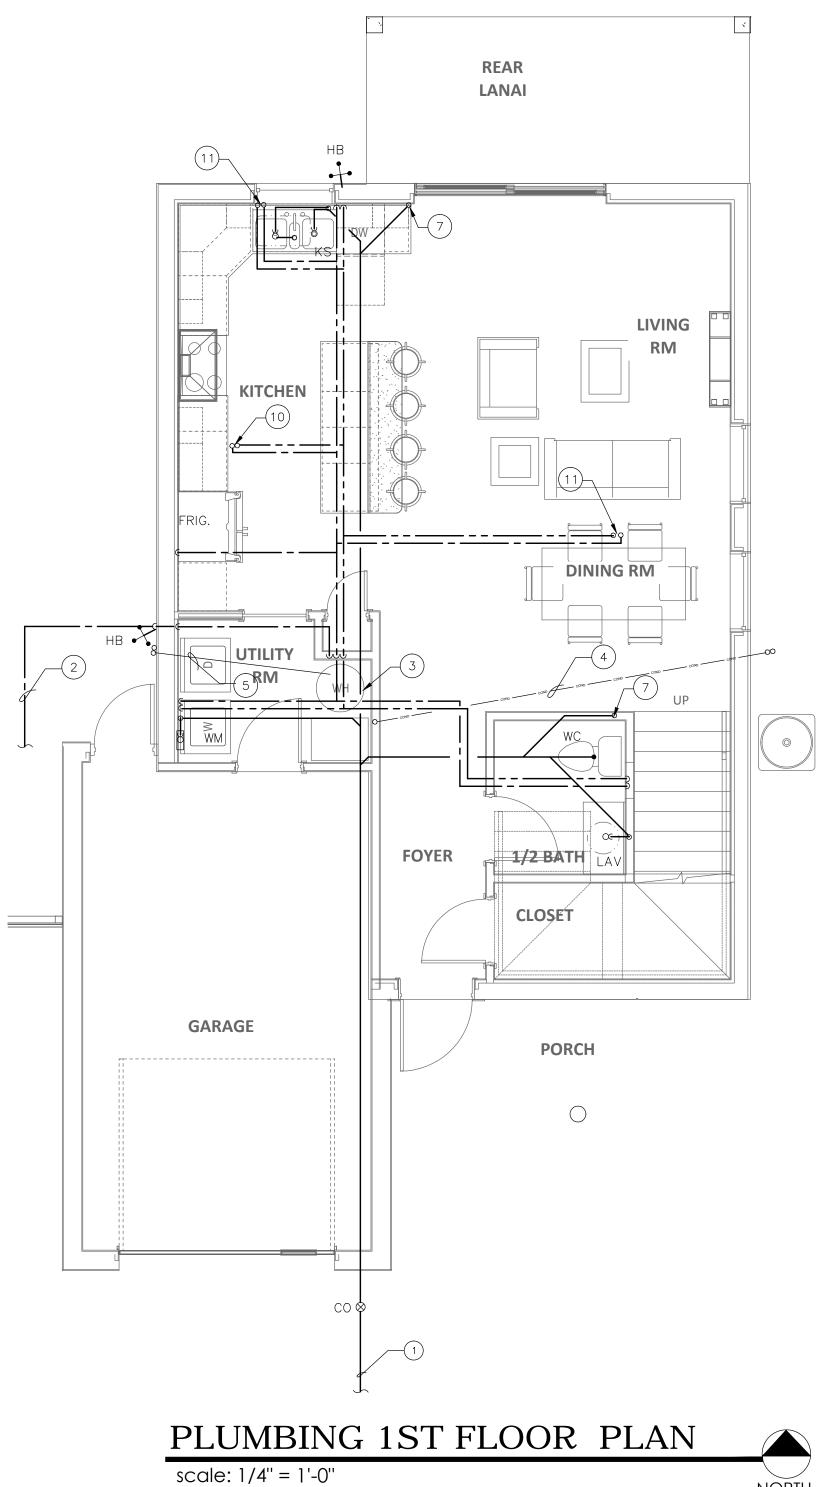

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GENERAL PLUMBING NOTES:

- 1. A. ALL WORK SHALL BE DONE IN ACCORDANCE WITH THE FBC (PLUMBING 2014) AND WITH ALL APPLICABLE REGULATIONS.
- B. DRAWINGS: REFÉR TO ALL DRAWINGS FOR COORDINATION OF THE PLUMBING WORK.C. ARRANGE AND PAY FOR ALL PERMITS, LICENSES, INSPECTIONS
- AND TESTS. OBTAIN THE REQUIRED CERTIFICATES AND PRESENT TO OWNER.

 D. GUARANTEE: THE COMPLETED INSTALLATION SHALL BE FULLY GUARANTEED AGAINST DEFECTIVE MATERIALS AND/OR IMPROPER

WORKMANSHIP FOR A MINIMUM OF ONE YEAR FOR MATERIAL AND

E. ALL HORIZONTAL SANITARY PIPING SHALL SLOPE AT 1/8 INCH PER FOOT MINIMUM FOR 3" AND LARGER AND AT 1/4" SLOPE FOR 2" PIPES AND SMALLER.

2. NOT USED.

3. PLUMBING FIXTURES: FIXTURES SHALL BE AS SELECTED BY OWNER AND SHALL BE FURNISHED AND INSTALLED BY THIS CONTRACTOR. FIXTURES SHALL BE COMPLETE WITH DRAINS, TRAPS, SUPPLIES AND ANY OTHER ACCESSORY REQUIRED. FIXTURES AND FAUCETS SHALL COMPLY WITH THE FBC WATER SAVING STANDARDS.

4. MATERIALS:

- A. PIPING:
 A. STORM, SOIL, WASTE AND VENT: SANITARY PIPE, PVC, DWV,
- SCHEDULE 40.

 B. DOMESTIC WATER: COPPER PIPE, TYPE L WITH SWEAT WROUGHT COPPER FITTINGS. TYPE "M" IN CONCEALED SPACES IS ACCEPTABLE FLOW GUARD CPVC AND PEX PIPING IS AN ACCEPTABLE SUBSTITUTION ISOLATE PIPING FROM CONCRETE WITH INSULATING MATERIAL.
- C. DOMESTIC WATER SUPPLY ASSEMBLY: STAINLESS STEEL BRAIDED SUPPLY LINE WITH ANGLE SHUT OFF VALVES.
- D. INSULATION: INSULATE ALL HOT WATER AND HOT RETURN WITH 1" FIBERGLASS INSULATION.
- 5 ALL ALITOMATIC FLECTRIC WATER HEATERS SHALL MEET TH
- 5. ALL AUTOMATIC ELECTRIC WATER HEATERS SHALL MEET THE
- STANDARDS OF THE LATEST ENERGY EFFICIENCY CODE.

 6. PIPING TEST AND DISINFECTIONS:


PER AWWA STANDARDS.


- A. TEST: ALL SANITARY AND DOMESTIC WATER SUPPLY PIPING SHALL BE TESTED FOR LEAKS BEFORE PIPING IS CONCEALED OR CONNECTED
- TO EQUIPMENT AND PLUMBING FIXTURES.

 B. DISINFECTION: ALL DOMESTIC WATER PIPING SHALL BE
 DISINFECTED BY INTRODUCING A SOLUTION OF CALCIUM
 HYPOCHLORITE OF 50 PARTS PER MILLION OF CHLORIDE AND AS
- . HOSE BIBBS: SHALL BE 1/2 INCH. ROUGH BRASS CONSTRUCTION WITH
- SHUT OFF VALVE AND VACUUM BREAKER.

 8. ALL OUTDOORS FLOOR CLEAN OUTS SHALL BE TERMINATED UP TO GRADE
- AND SHALL BE MARKED.

 9. CONTRACTOR SHALL COORDINATE EXACT LOCATION OF SANITARY,
 AND DOMESTIC WATER PIPING BEFORE STARTING ANY WORK. NOTIFY
 ARCHITECT/ENGINEER OF ANY DEVIATIONS FROM DESIGN DRAWINGS.

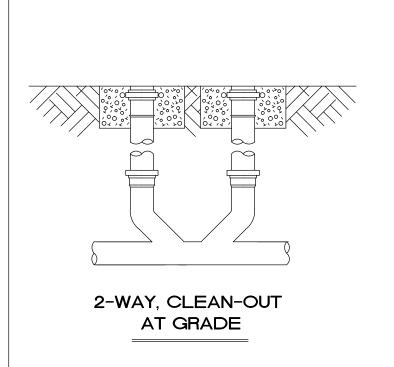

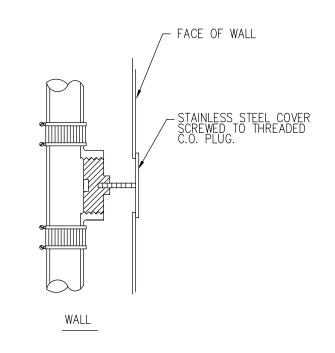

CLEANOUT DETAIL

PLUMBING SYMBOL LEGEND				
	SYMBOL	DESCRIPTION		
		SANITARY LINE		
		VENT LINE		
	→ →	SAFEWASTE LINE		
	——CD ——	CONDENSATE LINE		
		GATE VALVE		
		COLD WATER LINE HOT WATER LINE		
		HOT WATER LINE		
	P-	PLUMBING FIXTURE DESIGNATION		
	FCO	FLUSH CLEAN OUT		
	\Rightarrow	FLOOR PENETRATION		
	IП	AIR CHAMBER		
		AIIV SHAIIBELV		
	WCO	WALL CLEANOUT		
	VTR	VENT THRU ROOF		
	• COOG	CLEANOUT ON GRADE		
	• ↓ • HB	HOSE BIBB W/VB		

NAME	FIXTURE		MODEL #
** ******	. //// 5/15		
WC	WATER CLOSET (TANK)		SEE ARCHITECT DRAWINGS
LAV	DROP-IN LAVATORY		SEE ARCHITECT DRAWINGS
TUB/SHR	TUB/SHOWER		SEE ARCHITECT DRAWINGS
KS	KITCHEN SINK		SEE ARCHITECT DRAWINGS
WM	WASHER SUPPLY BOX		OATEY WASH BOX
ALL TUB AND SHOWE COMPLY WITH ASSE	ER VALVE SHALL BE ANTI-SCA 1016.	ALD AND SHALL	
FIXTURE	WATER PIPE SIZE	NOMINAL SAN. SIZE	MAXIMUM FLOW RATES
WATER CLOSET	T 1/2"	3"	1.28 GPF
LAVATORY	1/2"	1 1/4"	.5 GPM
TUB	1/2"	2"	2.0 GPM

